

1001 Boulders Parkway Suite 300 Richmond, VA 23225 P 804.200.6500 F 804.560.1016 www.timmons.com

RE: Keswick Estate Utilities, Inc. - Sewage Treatment Plant Upgrade - Project Description

The Keswick Sewage Treatment Plant (STP) serves the Keswick Hall and Golf Club, and residential homes, and has a current capacity of 60,000 gpd. Keswick Estate Utilities, Inc. is planning to upgrade their influent pump station and force main, and add an equalization tank to the Keswick STP. Timmons Group will be the design engineer on the project. Planning and design of the project is currently underway.

This project is required in order for the facility to comply with the State Water Control Law, Clean Water Act, and maintain their Virginia Pollutant Discharge Elimination System (VPDES) Permit with the Virginia Department of Environmental Quality (DEQ).


The main component of this project is the construction of a 100,000 gallon, above-grade, open-top, pre-cast concrete, equalization tank. Pre-cast concrete is shop formed and therefore has a very neat and smooth finish. As shown in the drawings, the tank will be located within the existing STP site. Existing grade at the location of the proposed tank varies from 361' to 367'. Existing grade rises toward I-64 and has an elevation of approximately 370' at the I-64 right of way (ROW) fence. The tank finished floor will be situated at elevation 358'. The tank will be 18' total in height. The top walkway elevation will be 376'.


There is an existing wastewater structure on the site that is similar to the proposed structure in make and materials. It also is an above-grade, open-top, concrete, wastewater tank. It has a top of walkway elevation of 376', which matches that of the proposed tank. However, it is much closer to I-64, with 20' separating the edge of the structure from the ROW line.

As the proposed tank is similar to the existing tank and will hold the same top of walkway elevation as the existing tank, there is no change to the general view from I-64. As existing grade increases towards I-64, this makes the current and proposed tanks nearly invisible to the average passerby.


Adjacent to the equalization tank will be a small pre-fabricated, concrete 10' x 12' electrical building and a small generator. The electrical building concrete wall will have a stamped brick finish.

1 EQ BASIN ELEVATION 1/4" = 1'-0"

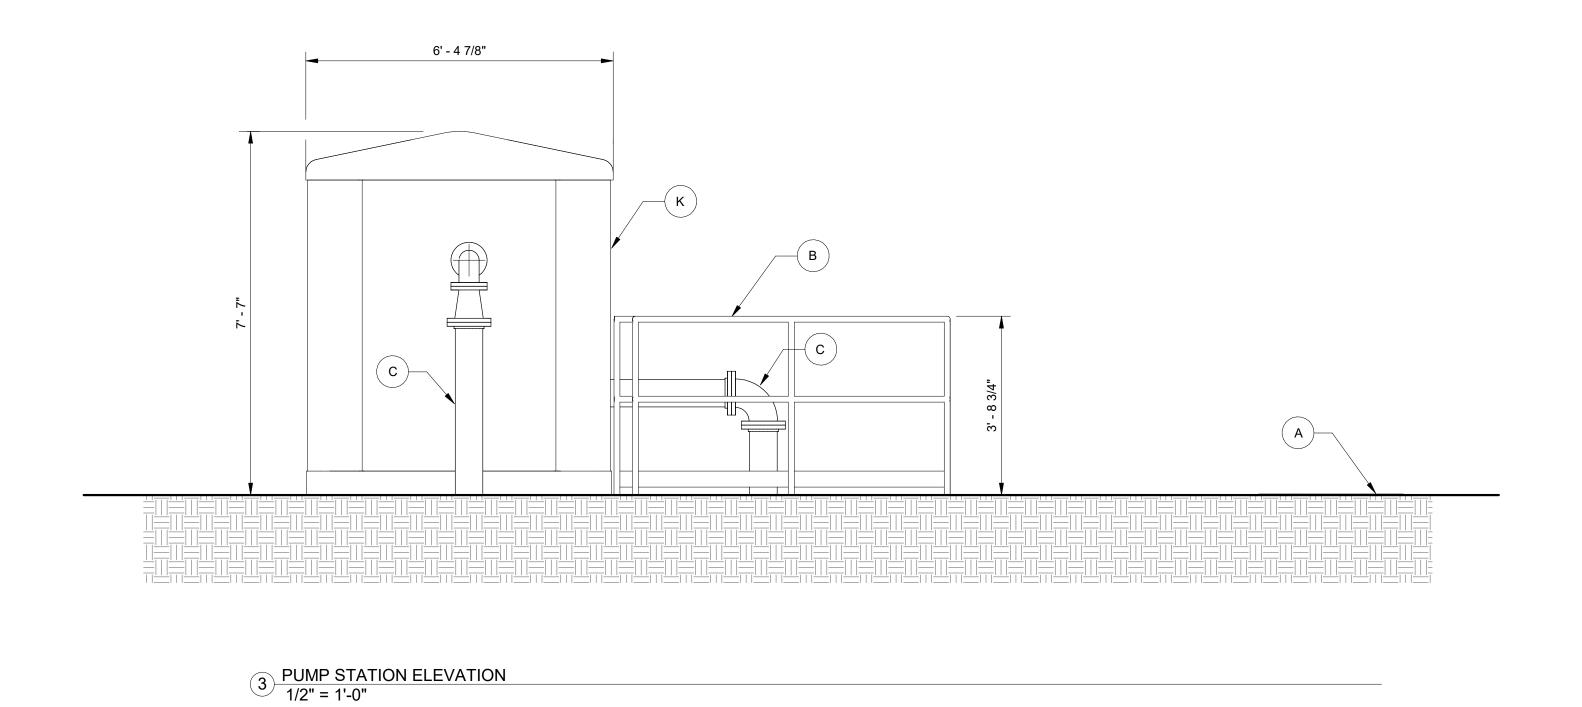

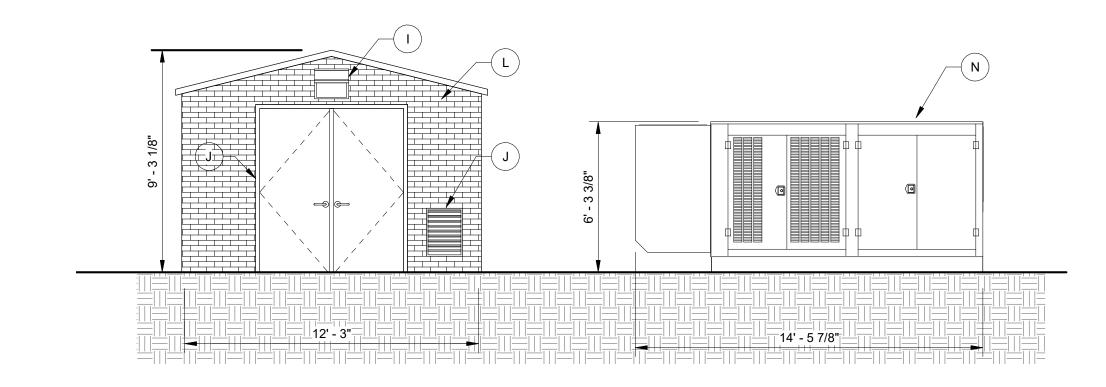

GENERATOR AND ELECTRICAL
BUILDING ELEVATION
1/4" = 1'-0"

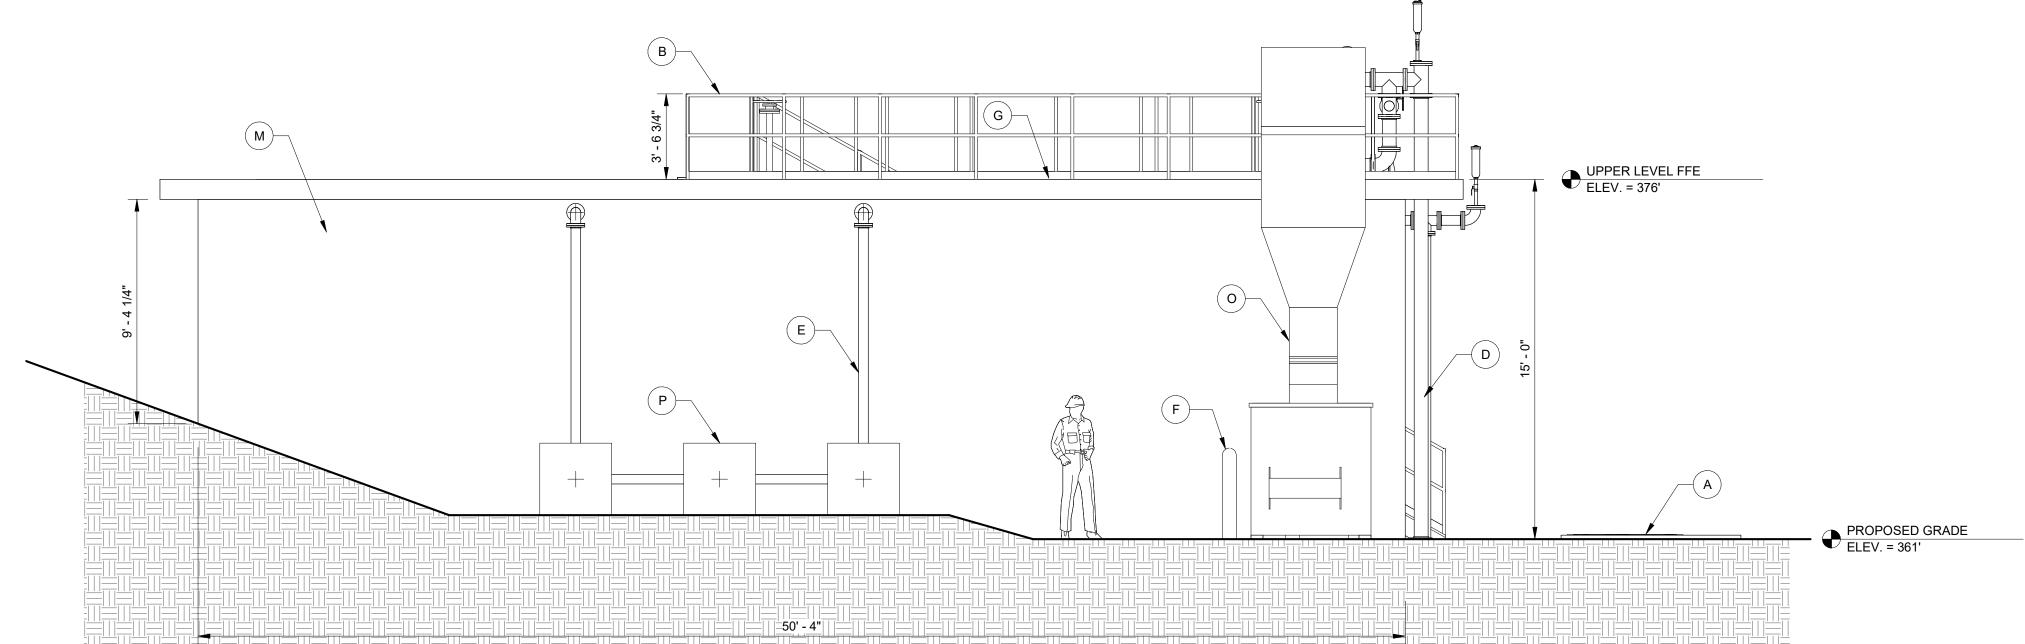

	MATERIAL SCHEDULE
A	HALLIDAY ALUMINUM ACCESS HATCH
В	ALUMINUM HAND RAIL
(c)	TINTED GREEN EPOXY COATED PIPING
D	ALUMINUM JACKETED PIPING
E	STAINLESS STEEL PIPING
F	CONCRETE BOLLARDS WITH YELLOW PAINT FINISH
G	CONCRETE FLOORING WITH SKID-PROOF COATING
Н	AMBICO 72"X84" FLUSH DOUBLE DOORS
	WALL PACK LIGHT
J	ALUMINUM WALL LOUVER
K	FIBERGLASS ENCLOSURE
L	PRECAST CONCRETE WITH RED BRICK STAMPED FINISH
M	PRECAST CONCRETE WITH SMOOTH STEEL TROWEL FINISH
N	STEEL GENERATOR ENCLOSURE
0	ALUMINUM SIDE HILL SCREEN
P	BLOWER PACKAGE

NOTE: MATERIAL SAMPLES PROVIDED TO ARB REPRESENT
MATERIALS L AND M IN THE ABOVE SCHEDULE. TWO SAMPLES HAVE
BEEN PROVIDED FOR THE ELECTRCIAL BUILDING WHICH WILL BE
EITHER PRECAST CONCRETE WITH A RED BRICK STAMPED FINISH OR
PRECAST CONCRETE WITH AN EXPOSED AGGREGATE FINISH.

NOT FOR CONSTRUCTION

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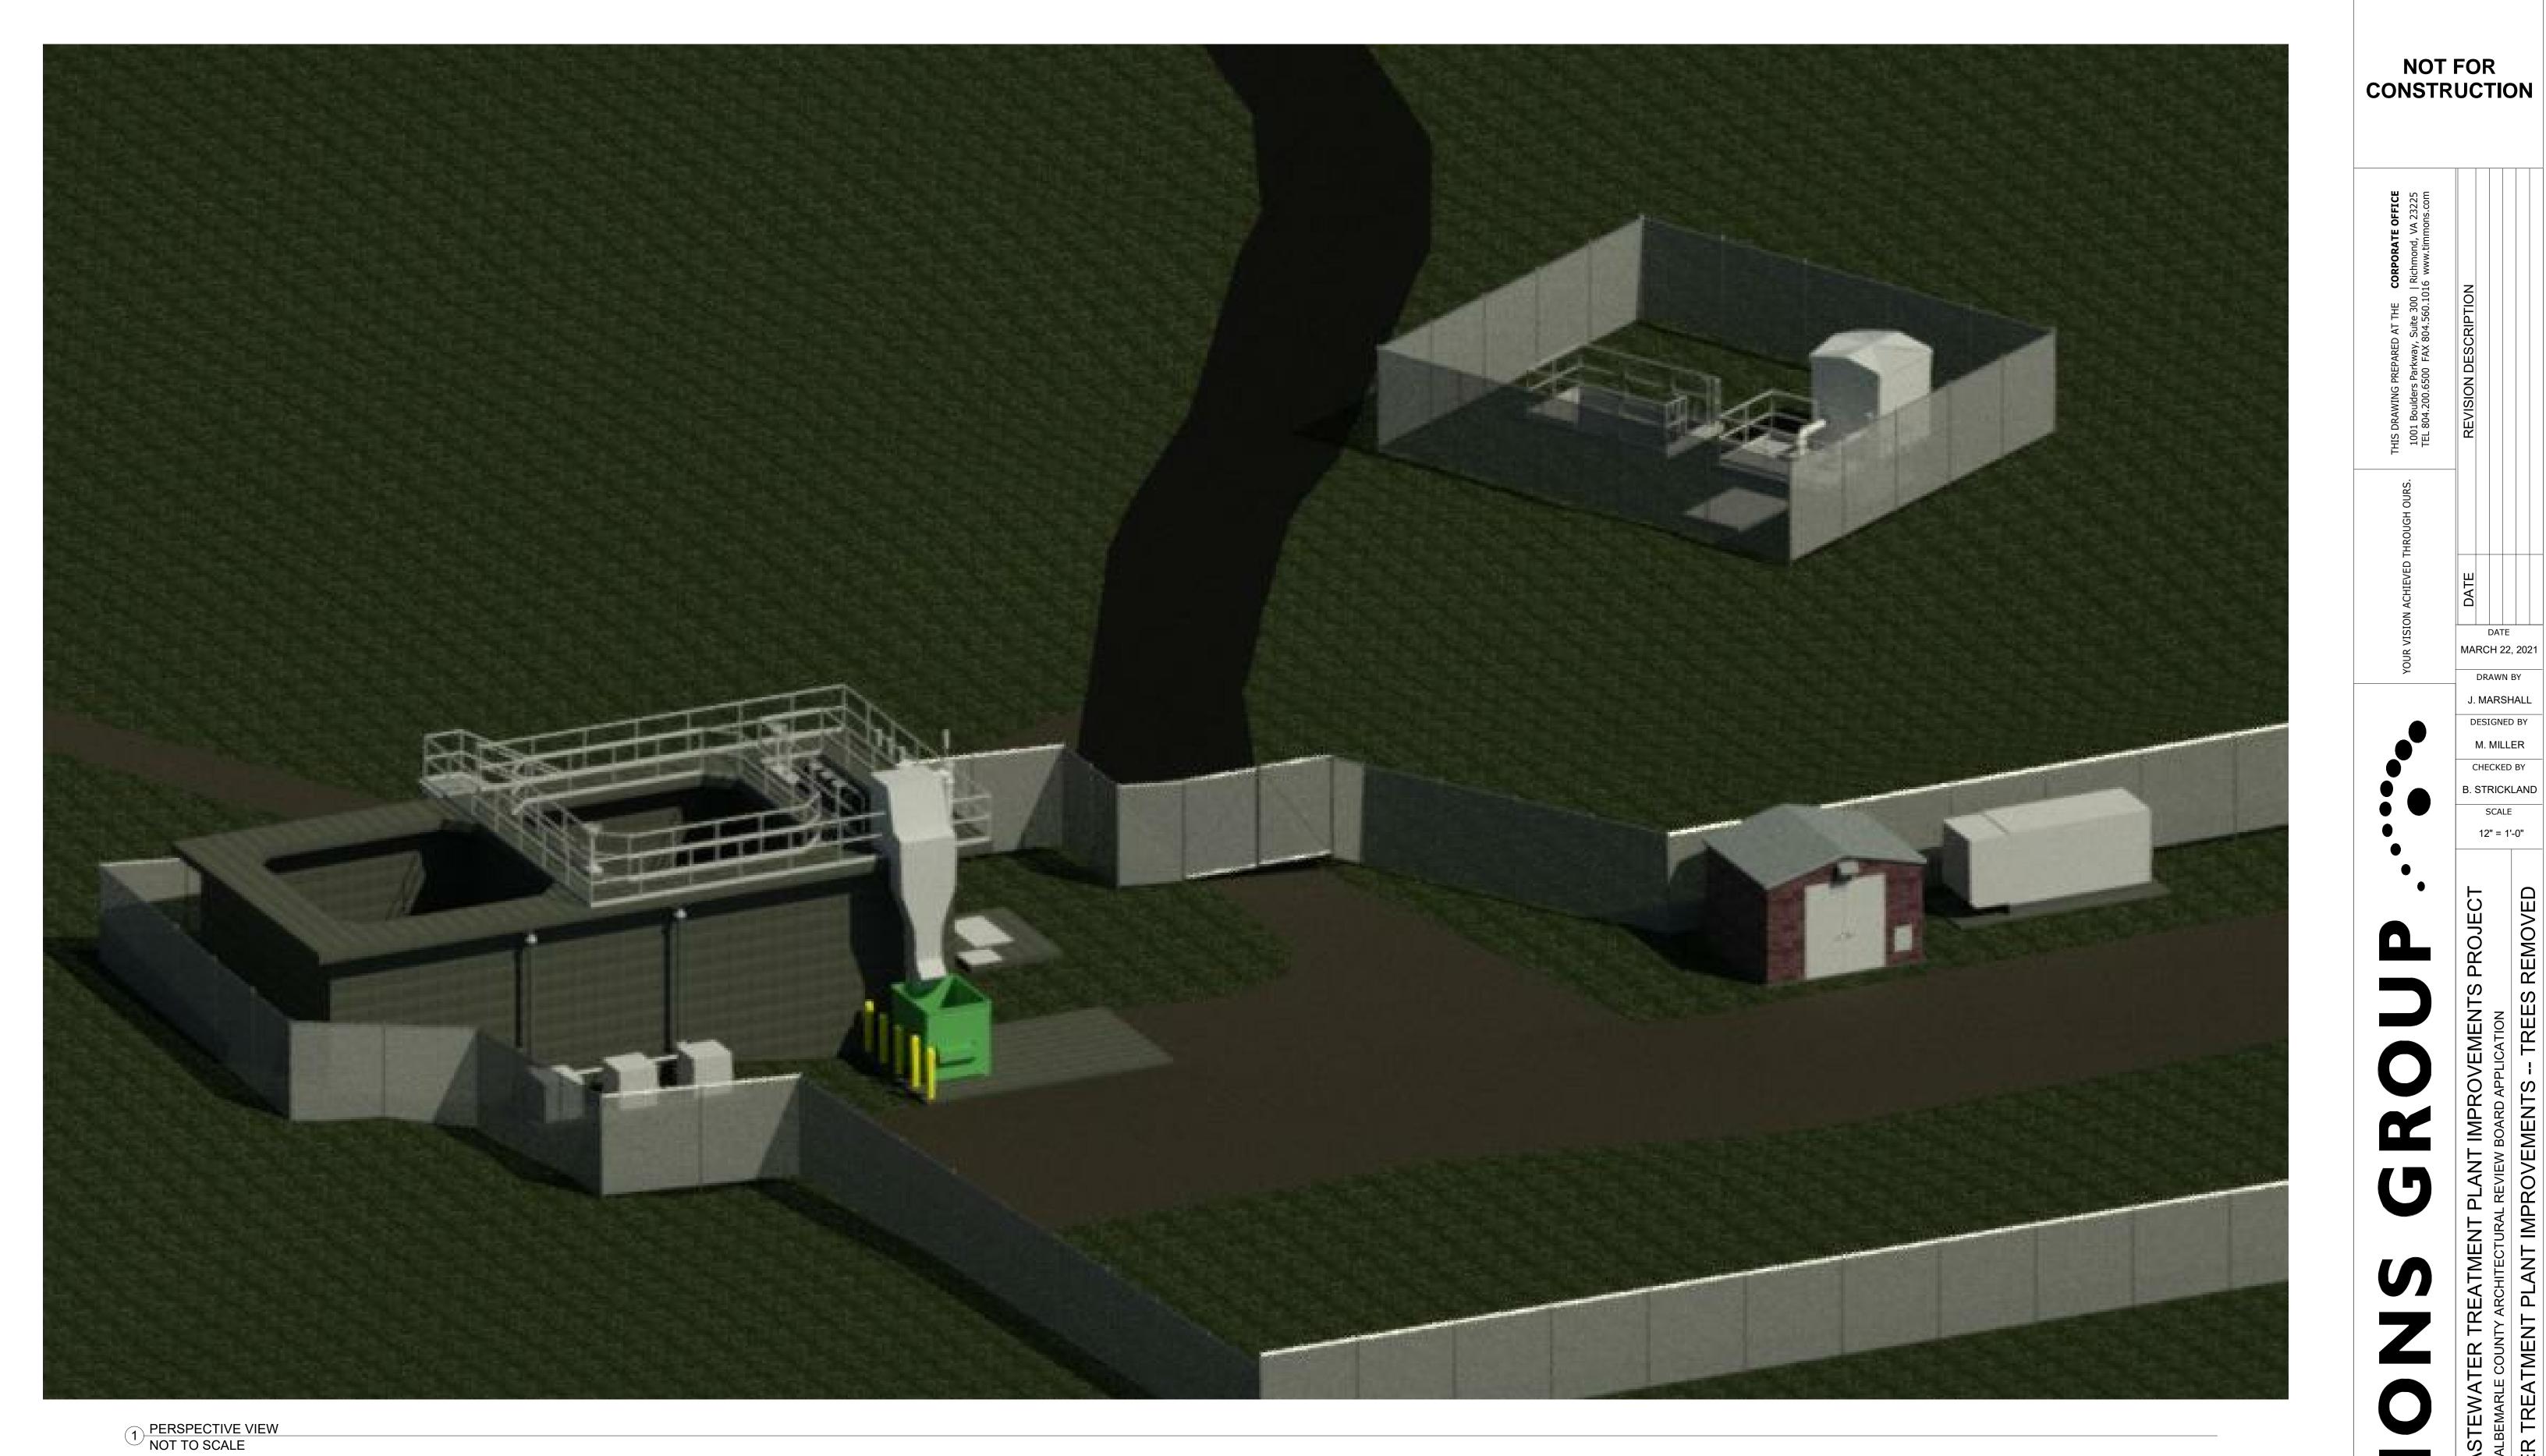
DATE MARCH 22, 2021 DRAWN BY J. MARSHALL

DESIGNED BY M. MILLER CHECKED BY B. STRICKLAND SCALE

As indicated

JOB NO.

40241 SHEET NO. EXHB-1



THIS DRAWING PREPARED AT THE CORPC 1001 Boulders Parkway, Suite 300 | Richm TEL 804.200.6500 FAX 804.560.1016 www

JOB NO. 40241 SHEET NO. EXHB-2

MARCH 22, 2021

DRAWN BY


J. MARSHALL

CHECKED BY

B. STRICKLAND

SCALE

12" = 1'-0"

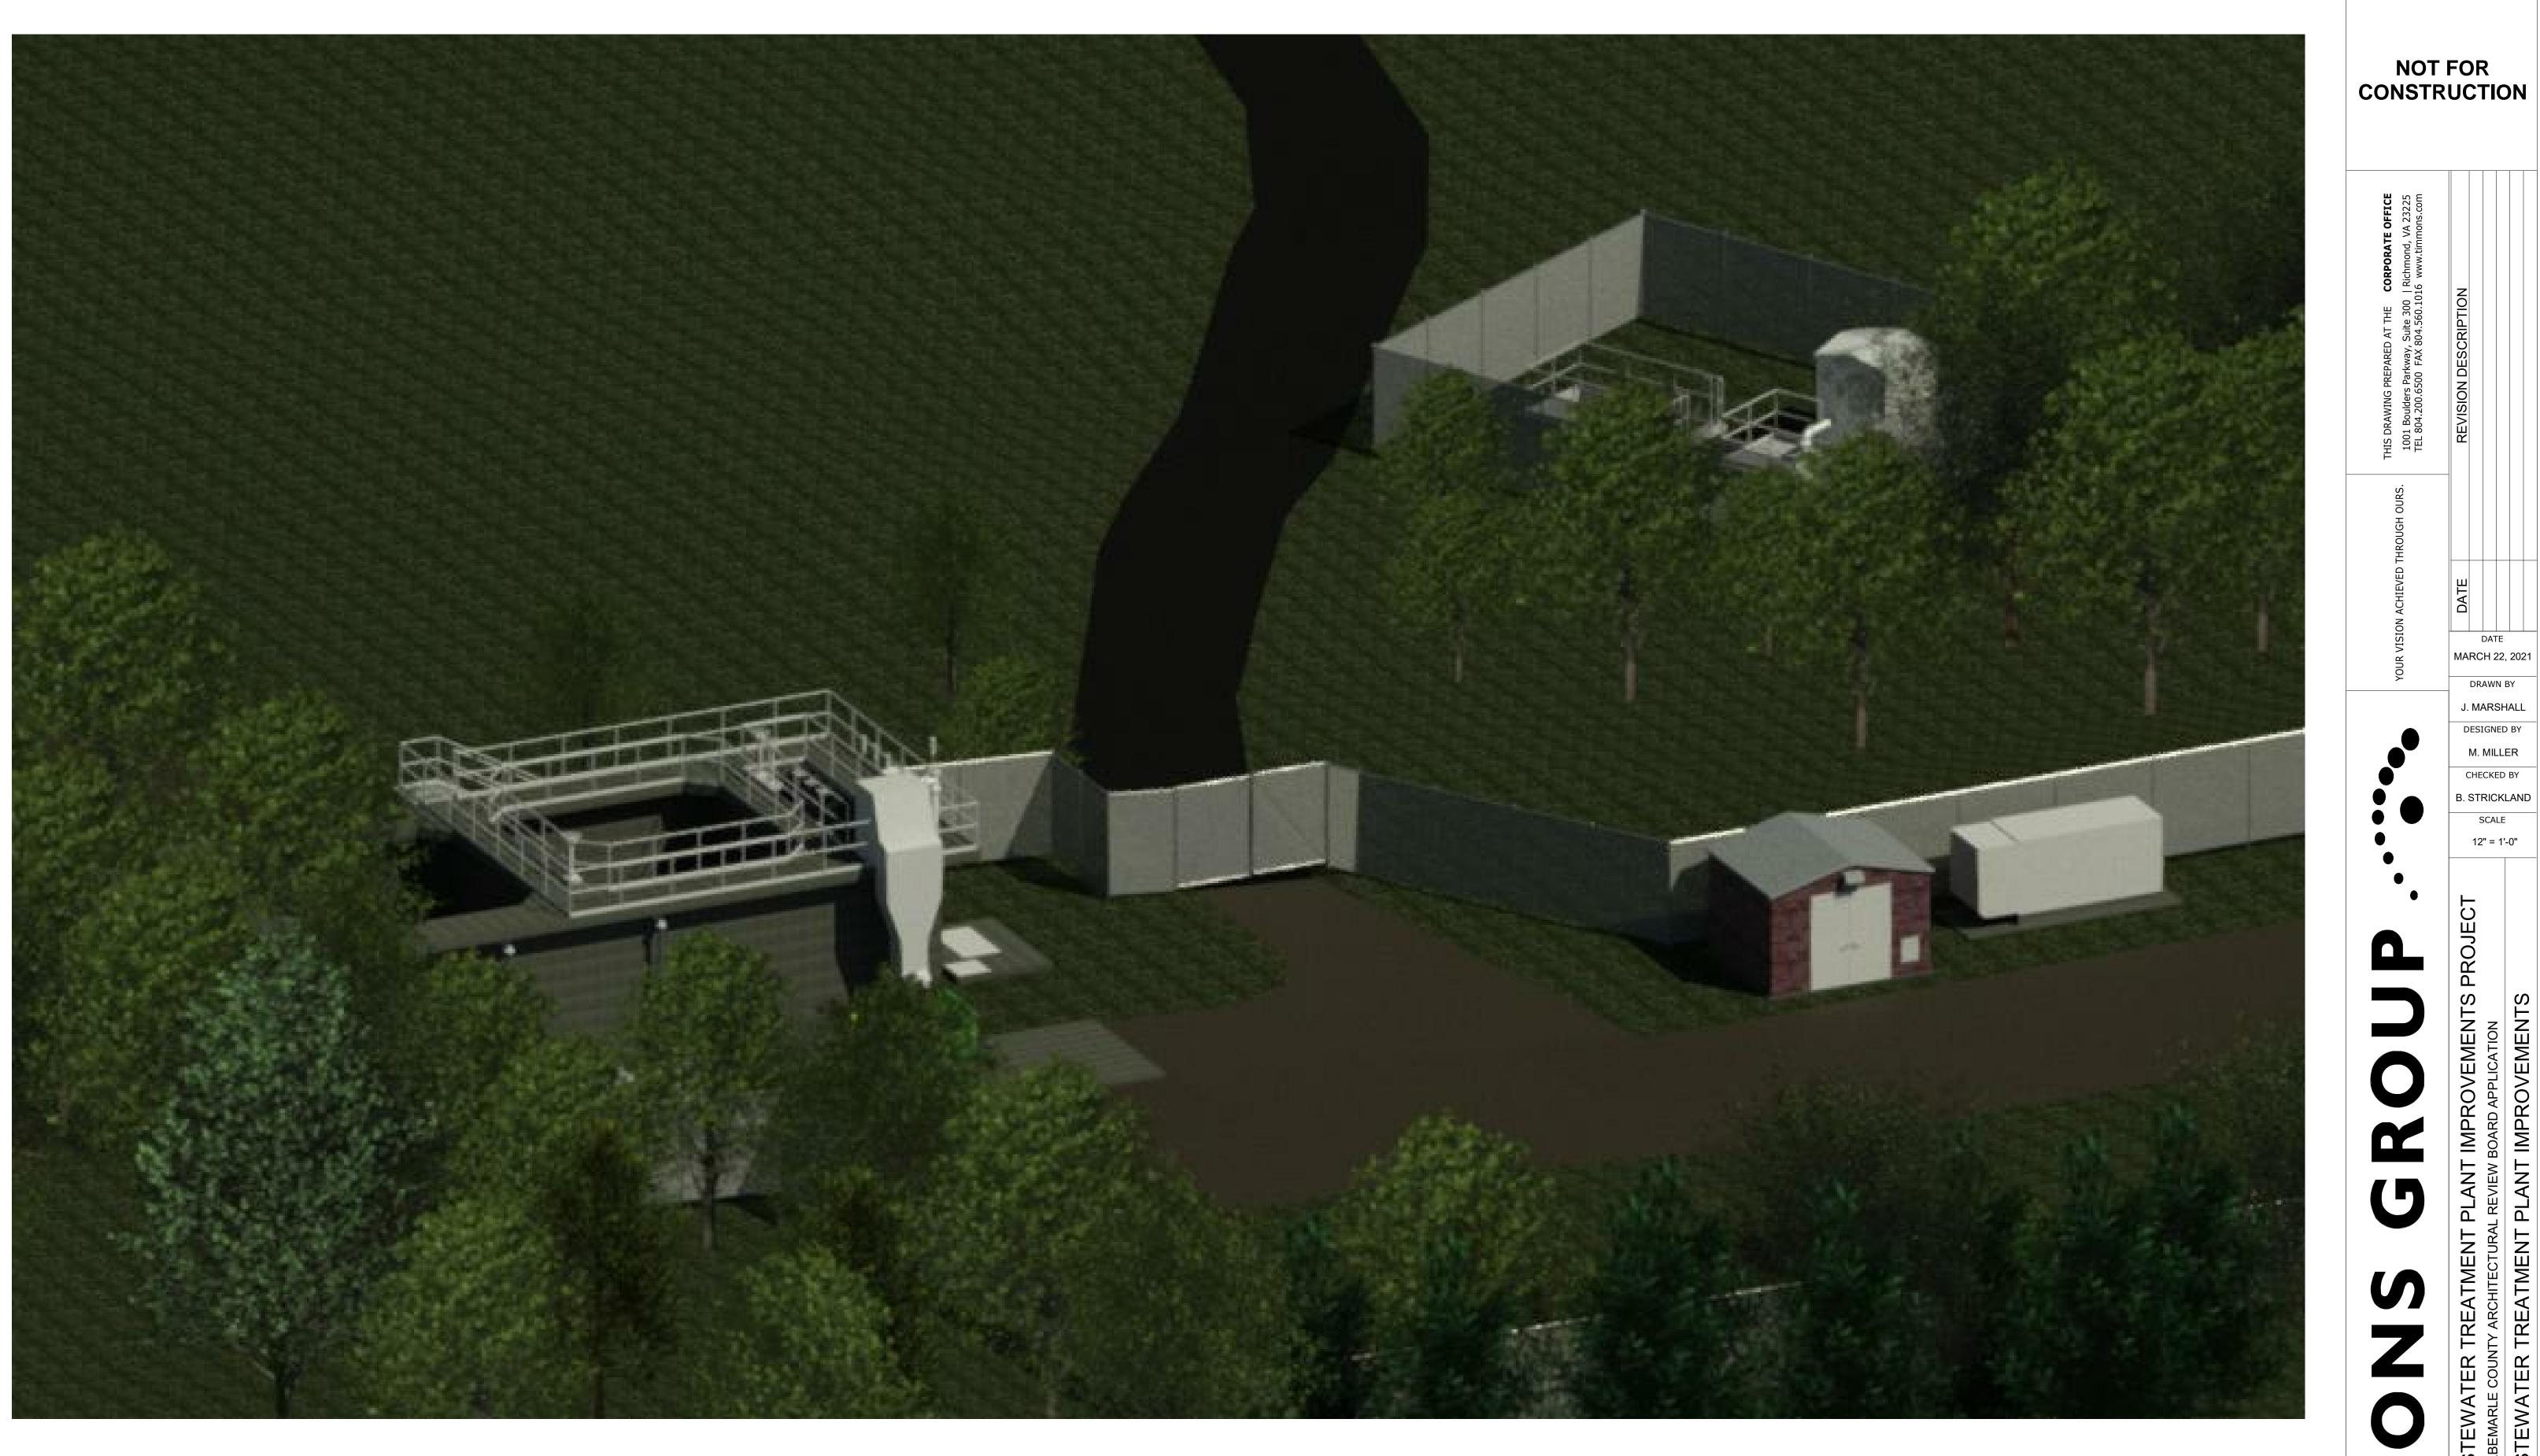

1 PERSPECTIVE VIEW NOT TO SCALE

B. STRICKLAND

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MARCH 22, 2021

DRAWN BY

J. MARSHALL

DESIGNED BY

M. MILLER

CHECKED BY

SCALE

12" = 1'-0"

JOB NO. 40241 SHEET NO. EXHB-3

KESWICK WASTEWATER TREATMENT PLANT IMPROVEMENTS

MINOR SITE PLAN AMENDMENT SDP199100097

COUNTY OF ALBEMARLE, VIRGINIA RIVANNA DISTRICT 03/22/2021



VICINITY MAP

SCALE: 1'' = 5,000'

OWNER:

KESWICK HALL AND GOLF CLUB 701 CLUB DRIVE KESWICK, VA 22947 CONTACT: JOHN TREVENEN TELEPHONE: (434) 979-3440 EMAIL: JTREVENEN@KESWICK.COM

ENGINEER OF RECORD:

TIMMONS GROUP 608 PRESTON AVE. SUITE 200, CHARLOTTESVILLE, VA 22903 CONTACT: JONATHAN SHOWALTER, P.E. TELEPHONE: 434-327-1681

Sheet List Table

Sheet Number	Sheet Title				
C0.0	COVER				
C1.0	NOTES AND DETAILS				
C2.0	EXISTING CONDITIONS AND DEMO PLAN				
C3.0	LAYOUT PLAN				
C4.0	GRADING AND DRAINAGE PLAN				
C5.0	STORMWATER PROFILES				
C6.0	INFLUENT FORCEMAIN PLAN AND PROFILE				
C6.1	EQ FM PLAN AND PROFILE				
L1.0	LANDSCAPE PLAN				
TOTAL SHEETS = 9					

SIGNATURE PANEL

ENGINEERING

INSPECTIONS

HEALTH DEPARTMENT

PLANNING & ZONING


DEPARTMENT OF COMMUNITY DEVELOPMENT

ARCHITECTURAL REVIEW BOARD

ALBEMARLE COUNTY SERVICE AUTHORITY

VIRGINIA DEPARTMENT OF TRANSPORTATION

DEPARTMENT OF FIRE AND RESCUE

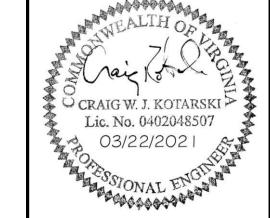

3/22/2021 A. MABEE DESIGNED B . SHOWALTER

C. KOTARSKI AS SHOWN

47747 C0.0

SITE DATA:

ZONING: RA

SETBACK: 75' FRONT

25' SIDE 35' REAR

MAGISTERIAL DISTRICT: RIVANNA

WETLAND IMPACTS: NONE

WATER SUPPLY: NONE

ENGINEER: TIMMONS GROUP

608 PRESTON AVENUE. SUITE 200 CHARLOTTESVILLE, VA 22902 TELEPHONE: 434-327-1681

LIMITS OF DISTURBANCE: 0.22 AC (9,233 SF)

CONTACT: JONATHAN SHOWALTER, P.E

SOURCE TOPOGRAPHY: TIMMONS GROUP. FEB. 23 & 24 2021

SANITARY SEWER: EXISTING WASTEWATER TREATMENT PLANT

THERE ARE NO CRITICAL SLOPES LOCATED WITHIN THE PROJECT LIMITS.

THE SITE IS NOT LOCATED IN A WATER SUPPLY PROTECTION DISTRICT.

THERE ARE NO CONSTRUCTION ACTIVITIES PROPOSED WITHIN THE 100-YR FLOODPLAIN

DRAINAGE DISTRICT: MIDDLE RIVANNA RIVER

NAD83 VIRGINIA STATE GRID SOUTH ZONE

EXISTING WASTEWATER TREATMENT PLANT SITE IMPROVEMENTS

GENERAL NOTES

- CONTRACTOR SHALL COORDINATE ALL REQUIREMENTS FOR AS BUILT DOCUMENTATION, AS REQUIRED BY THE LOCALITY. THIS INCLUDES, BUT IS NOT LIMITED TO, TESTING, INSTALLATION DOCUMENTATION, SURVEY, ETC. ALL REQUIREMENTS SHALL BE DISCUSSED WITH THE LOCALITY PRIOR TO BEGINNING CONSTRUCTION.
- ALL MATERIALS AND CONSTRUCTION SHALL BE IN ACCORDANCE WITH CURRENT VIRGINIA DEPARTMENT OF
- TRANSPORTATION'S SPECIFICATIONS AND STANDARDS. PRIOR TO ANY CONSTRUCTION, THE CONTRACTOR SHALL CONSULT THE ENGINEER AND VERIFY THE APPROVAL OF THE
- PLANS BY ALL FEDERAL, STATE AND LOCAL AGENCIES. LAND USE PERMITS (LUP-A) MUST BE OBTAINED FROM THE VIRGINIA DEPARTMENT OF TRANSPORTATION PRIOR TO
- BEGINNING ANY CONSTRUCTION WITHIN THE EXISTING STATE MAINTAINED RIGHT OF WAY (INCLUDING ACCESS).
- VDOT IS TO RECEIVE WRITTEN NOTIFICATION 48 HOURS PRIOR TO COMMENCING WITH INITIAL CONSTRUCTION ACTIVITIES. THE CONTRACTOR SHALL VERIFY THE ELEVATIONS OF ALL POINTS OF CONNECTION OR PROPOSED WORK TO EXISTING
- UPON DISCOVERY OF SOILS THAT ARE UNSUITABLE FOR FOUNDATIONS, SUBGRADES, OR OTHER ROADWAY CONSTRUCTION PURPOSES, THE CONTRACTOR SHALL IMMEDIATELY CONTACT THE OWNER. THESE AREAS SHALL BE EXCAVATED BELOW PLAN GRADE AS DIRECTED BY THE OWNER'S REPRESENTATIVE. BACKFILLED WITH SUITABLE MATERIAL AND COMPACTED IN ACCORDANCE WITH SPECIFICATIONS.
- ALL STORM SEWER DESIGN AND CONSTRUCTION TO BE IN ACCORDANCE WITH VDOT STANDARDS
- ALL STORM SEWER PIPE SHALL BE REINFORCED TONGUE AND GROVE CONCRETE PIPE IN ACCORDANCE WITH ASTM-C-76. PIPE WITHIN THE RIGHT OF WAY SHALL BE MINIMUM CLASS III OR GREATER IN ACCORDANCE WITH CURRENT VDOT STANDARDS AND SPECIFICATIONS.
- IF PRE-CAST UNITS ARE TO BE USED, VDOT SHALL BE NOTIFIED AND THE MANUFACTURER SHALL SUBMIT DRAWING DETAILS
- FOR REVIEW. CERTIFICATION AND VDOT STAMP WILL BE REQUIRED ON ALL UNITS.

CURBS, SANITARY LINES, WATERLINES, ETC, PRIOR TO CONSTRUCTION.

- 10. ALL CONCRETE SHALL BE A3-AE (AIR ENTRAINED 3,000 PSI), UNLESS OTHERWISE NOTED. 11. ALL ENTRANCES ARE TO BE DESIGNED AND CONSTRUCTED IN ACCORDANCE WITH CURRENT VDOT STANDARDS.
- 12. DESIGN CHANGES, SPECIFIED MATERIALS CHANGES AND/OR FIELD CHANGES FROM THE APPROVED PLANS NEED TO BE RESUBMITTED TO THE ENGINEER PRIOR TO PROCEEDING WITH THE WORK. A LETTER OF EXPLANATION SHALL ACCOMPANY THE REVISED PLANS AND/OR THE DRAINAGE CALCULATIONS, WHICH MUST BE SUBMITTED AND APPROVED BY THE
- 13. CONTRACTOR SHALL VERIFY LOCATION AND ELEVATION OF ALL UNDERGROUND UTILITIES SHOWN ON PLANS IN AREAS OF CONSTRUCTION PRIOR TO STARTING WORK. CONTACT ENGINEER IMMEDIATELY IF LOCATION OR ELEVATION IS DIFFERENT FROM THAT SHOWN ON PLAN. IF THERE APPEARS TO BE A CONFLICT, AND/OR UPON DISCOVERY OF ANY UTILITY NOT SHOWN ON THIS PLAN, CALL MISS UTILITY OF CENTRAL VIRGINIA AT 1-800-552-7001. THE OWNER SHALL BE RESPONSIBLE FOR THE RELOCATION OF ANY UTILITY WITHIN EXISTING AND/OR PROPOSED RIGHT-OF-WAY REQUIRED BY THE DEVELOPMENT.
- CASING SLEEVES SHALL BE PLACED AT ALL ROAD CROSSINGS FOR GAS, POWER, TELEPHONE AND CABLE TV SERVICE
- THE INSTALLATION OF SEWER, WATER, AND GAS MAINS (INCLUDING SERVICE LATERALS AND SLEEVES) SHALL BE COMPLETED PRIOR TO THE PLACEMENT OF AGGREGATE BASE COURSE.
- 16. VDOT & ALBEMARLE COUNTY APPROVAL OF CONSTRUCTION PLANS DOES NOT PRECLUDE THE RIGHT TO REQUIRE ADDITIONAL FACILITIES AS DEEMED NECESSARY
- 17. VDOT SHALL HAVE APPROVED THE AGGREGATE BASE COURSE(S) FOR DEPTH, TEMPLATE AND PERFORMED THE REQUIRED FIELD INSPECTION (PROOF ROLL) PRIOR TO PLACEMENT OF ANY SURFACE COURSE(S). CONTACT THE OWNER'S REPRESENTATIVE FOR INSPECTION FOR THE AGGREGATE BASE COURSE(S) 48 HOURS PRIOR TO APPLICATION OF THE SURFACE COURSE(S)
- 18. A PRIME COAT SEAL BETWEEN THE AGGREGATE BASE AND BITUMINOUS CONCRETE WILL BE REQUIRED AT THE RATE OF 0.30 GALLONS PER SQUARE YARD (REC-250 PRIME COAT) PER VDOT STANDARDS AND SPECIFICATIONS.
- THE SCHEDULING OF AGGREGATE BASE INSTALLATION AND SUBSEQUENT PAVING ACTIVITIES SHALL ACCOMMODATE
- FORECAST WEATHER CONDITIONS PER SECTION 315 OF THE ROAD AND BRIDGE SPECIFICATIONS 20. THE OWNER'S REPRESENTATIVE SHALL HAVE APPROVED THE AGGREGATE BASE COURSE(S) FOR DEPTH, TEMPLATE AND PERFORMED THE REQUIRED FIELD INSPECTION (PROOF ROLL) PRIOR TO PLACEMENT OF ANY SURFACE COURSE(S). CONTACT THE OWNER FOR INSPECTION FOR THE AGGREGATE BASE COURSE(S) 48 HOURS PRIOR TO APPLICATION OF THE
- SURFACE COURSE(S) 21. A GEOTECHNICAL ENGINEER IS TO ASCERTAIN CAUSE AND CERTIFY RECOMMENDED METHOD OF REPAIR FOR ALL
- PAVEMENT STRUCTURAL FAILURES PRIOR TO STATE ACCEPTANCE. (N/A) 22. ALL VEGETATION AND ORGANIC MATERIAL IS TO BE REMOVED FROM THE PROPOSED PAVEMENT LIMITS PRIOR TO
- CONDITIONING OF THE SUBGRADE 23. CERTIFICATION AND SOURCE OF MATERIALS ARE TO BE SUBMITTED TO THE OWNER'S REPRESENTATIVE FOR ALL MATERIALS
- AND BE IN ACCORDANCE WITH THE ROAD AND BRIDGE SPECIFICATIONS, AND ROAD AND BRIDGE STANDARDS 24. APPROVAL OF A DETAILED CONSTRUCTION SEQUENCING/MAINTENANCE OF TRAFFIC NARRATIVE FOR THE WORK ZONE IS A PREREQUISITE FOR ISSUANCE OF A LAND USE PERMIT ALLOWING ACCESS TO AND CONSTRUCTION WITHIN VDOT MAINTAINED RIGHT OF WAY. (N/A)
- 25. GRADE LINES ON PROFILES DENOTE FINISHED GRADE OF CENTER LINE
- OF ROAD. (N/A) 26. ALL APPROACH GUTTERS TO SAG INLETS SHALL MAINTAIN A MINIMUM
- SLOPE OF 0.004 ft./ft.
- 27. WHERE A TYPE "B" NOSE IS SPECIFIED ON AN INLET IN CONJUNCTION WITH ROLL FACE CURB AND GUTTER OR CG-7, THERE SHALL BE A 20' TRANSITION ON EACH SIDE OF THE INLET. (N/A)
- CONTRACTOR SHALL PROVIDE A SEQUENCE OF CONSTRUCTION/MAINTENANCE OF TRAFFIC PLAN IN ACCORDANCE WITH THE STANDARDS AND GUIDELINES CONTAINED IN THE 2011 EDITION OF THE VIRGINIA WORK AREA PROTECTION MANUAL FOR REVIEW BY THE ENGINEER, OWNER'S REPRESENTATIVE, AND VDOT PRIOR TO STARTING WORK THAT IMPACTS TRAFFIC ON STATE ROADS.
- 29. ALL NEW HANDICAP ACCESSIBLE REQUIREMENTS ON-SITE AND WITHIN ALL NEW STRUCTURES SHALL COMPLY WITH THE
- 2006 UNIFORM STATEWIDE BUILDING CODE, 2006 VIRGINIA CONSTRUCTION CODE, AND ICC/ANSI A117.1-03. 30. THE CLEAR ZONE IS TO BE FREE OF STORED MATERIALS AND PARKED EQUIPMENT.
- HORIZONTAL AND VERTICAL SIGHT DISTANCES SHALL BE FREE OF PARKED VEHICLES.
- 32. ALL EXCAVATED AREAS WITHIN THE CLEAR ZONE THAT HAVE A DEPTH GREATER THAN 6" SHALL HAVE A 6:1 STONE WEDGE PLACED AT THE END OF THE DAY
- 33. VISIBILITY OF ALL MECHANICAL EQUIPMENT FROM THE ENTRANCE CORRIDOR SHALL BE ELIMINATED.

ALBEMARLE COUNTY ENGINEERING GENERAL CONSTRUCTION NOTES


- PRIOR TO ANY CONSTRUCTION WITHIN ANY EXISTING PUBLIC RIGHT OF WAY, INCLUDING CONNECTION TO ANY EXISTING ROAD, A PERMIT SHALL BE OBTAINED FROM THE VIRGINIA DEPARTMENT OF TRANSPORTATION (VDOT). THIS PLAN AS DRAWN MAY NOT ACCURATELY REFLECT THE REQUIREMENTS OF THE PERMIT. WHERE ANY DISCREPANCIES OCCUR THE REQUIREMENTS OF THE PERMIT SHALL GOVERN.
- ALL MATERIALS AND CONSTRUCTION METHODS SHALL CONFORM TO CURRENT SPECIFICATIONS AND STANDARDS OF VDOT. EROSION AND SILTATION CONTROL MEASURES SHALL BE PROVIDED IN ACCORDANCE WITH THE APPROVED EROSION
- CONTROL PLAN AND MUST BE INSTALLED PRIOR TO ANY CLEARING, GRADING OR OTHER CONSTRUCTION.
- ALL SLOPES AND DISTURBED AREAS ARE TO BE FERTILIZED, SEEDED AND MULCHED. THE MAXIMUM ALLOWABLE SLOPE IS 2:1 (HORIZONTAL: VERTICAL). WHERE REASONABLY OBTAINABLE, LESSER SLOPES OF 3:1
- OR BETTER ARE TO BE ACHIEVED. PAVED, RIP-RAP OR STABILIZATION MAT LINED DITCH MAY BE REQUIRED WHEN IN THE OPINION OF THE COUNTY ENGINEER,
- OR DESIGNEE, IT IS DEEMED NECESSARY IN ORDER TO STABILIZE A DRAINAGE CHANNEL.
- ALL TRAFFIC CONTROL SIGNS SHALL CONFORM WITH THE VIRGINIA MANUAL FOR UNIFORM TRAFFIC CONTROL DEVICES. UNLESS OTHERWISE NOTED ALL CONCRETE PIPE SHALL BE REINFORCED CONCRETE PIPE - CLASS III.
- ALL EXCAVATION FOR UNDERGROUND PIPE INSTALLATION MUST COMPLY WITH OSHA STANDARDS FOR THE CONSTRUCTION
- INDUSTRY (29 CFR PART 1926).
- RETAINING WALLS GREATER THAN 3 FEET IN HEIGHT REQUIRE A SEPARATE BUILDING PERMIT. WALLS EXCEEDING 4 FEET IN HEIGHT REQUIRE A STAMPED ENGINEERED DESIGN ALSO. WALLS REQUIRE INSPECTIONS AS OUTLINED IN THE USBC.
- ALL WATER LINES, SEWER LINES, AND FIRE LINES FROM THE MAIN TO THE STRUCTURE MUST HAVE A VISUAL INSPECTION PERFORMED BY THE BUILDING DEPARTMENT.

BLASTING NOTES

1. BLASTING SHALL NOT BE PERMITTED ON THIS PROJECT.

ALBEMARLE COUNTY STORMWATER MANAGEMENT NOTES

- ALL DAMS AND CONSTRUCTED FILL TO BE WITHIN 95% OF MAXIMUM DRY DENSITY AND 2% OF OPTIMUM MOISTURE CONTENT. ALL FILL MATERIAL TO BE APPROVED BY A GEOTECHNICAL ENGINEER. A GEOTECHNICAL ENGINEER IS TO BE PRESENT DURING CONSTRUCTION OF DAMS.
- PIPE AND RISER JOINTS ARE TO BE WATERTIGHT WITHIN STORMWATER MANAGEMENT FACILITIES.
- FOR TEMPORARY SEDIMENT TRAPS OR BASINS WHICH ARE TO BE CONVERTED TO PERMANENT STORMWATER MANAGEMENT FACILITIES; CONVERSION IS NOT TO TAKE PLACE UNTIL THE SITE IS STABILIZED, AND PERMISSION HAS BEEN OBTAINED FROM THE COUNTY EROSION CONTROL INSPECTOR.

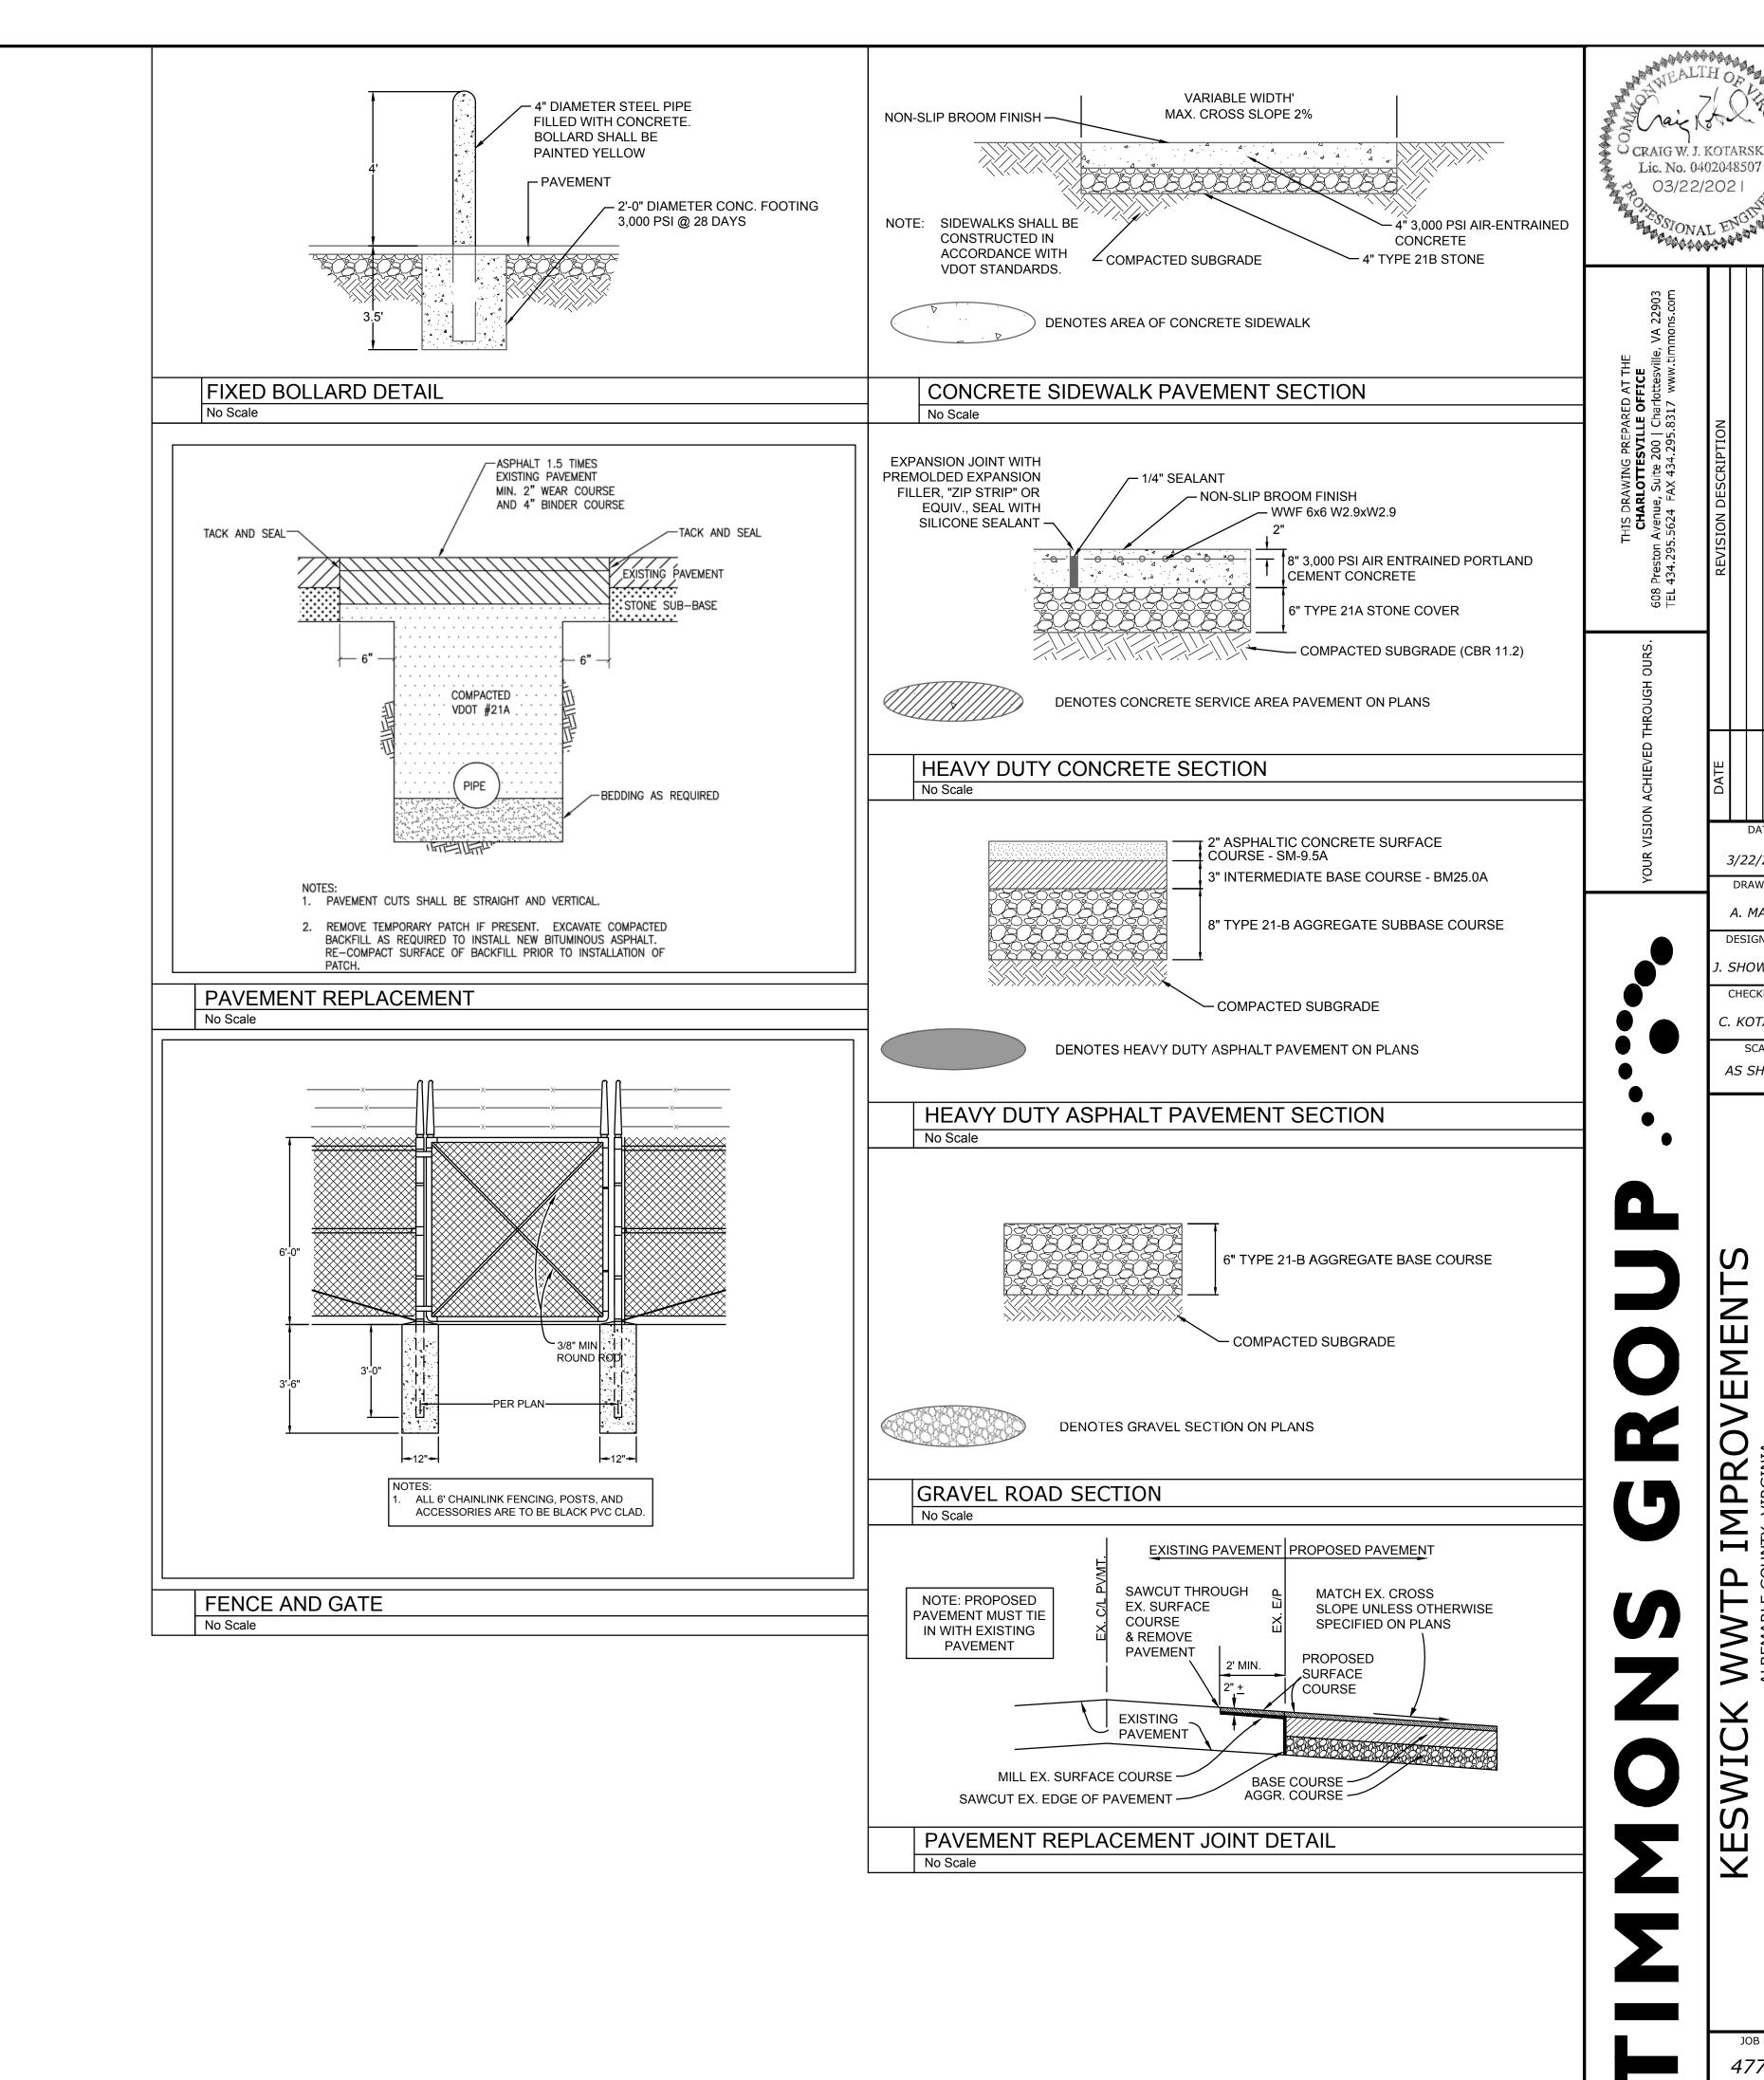

3/22/2021

DRAWN BY

A. MABEE

DESIGNED BY

SHOWALTER

CHECKED BY


. KOTARSKI


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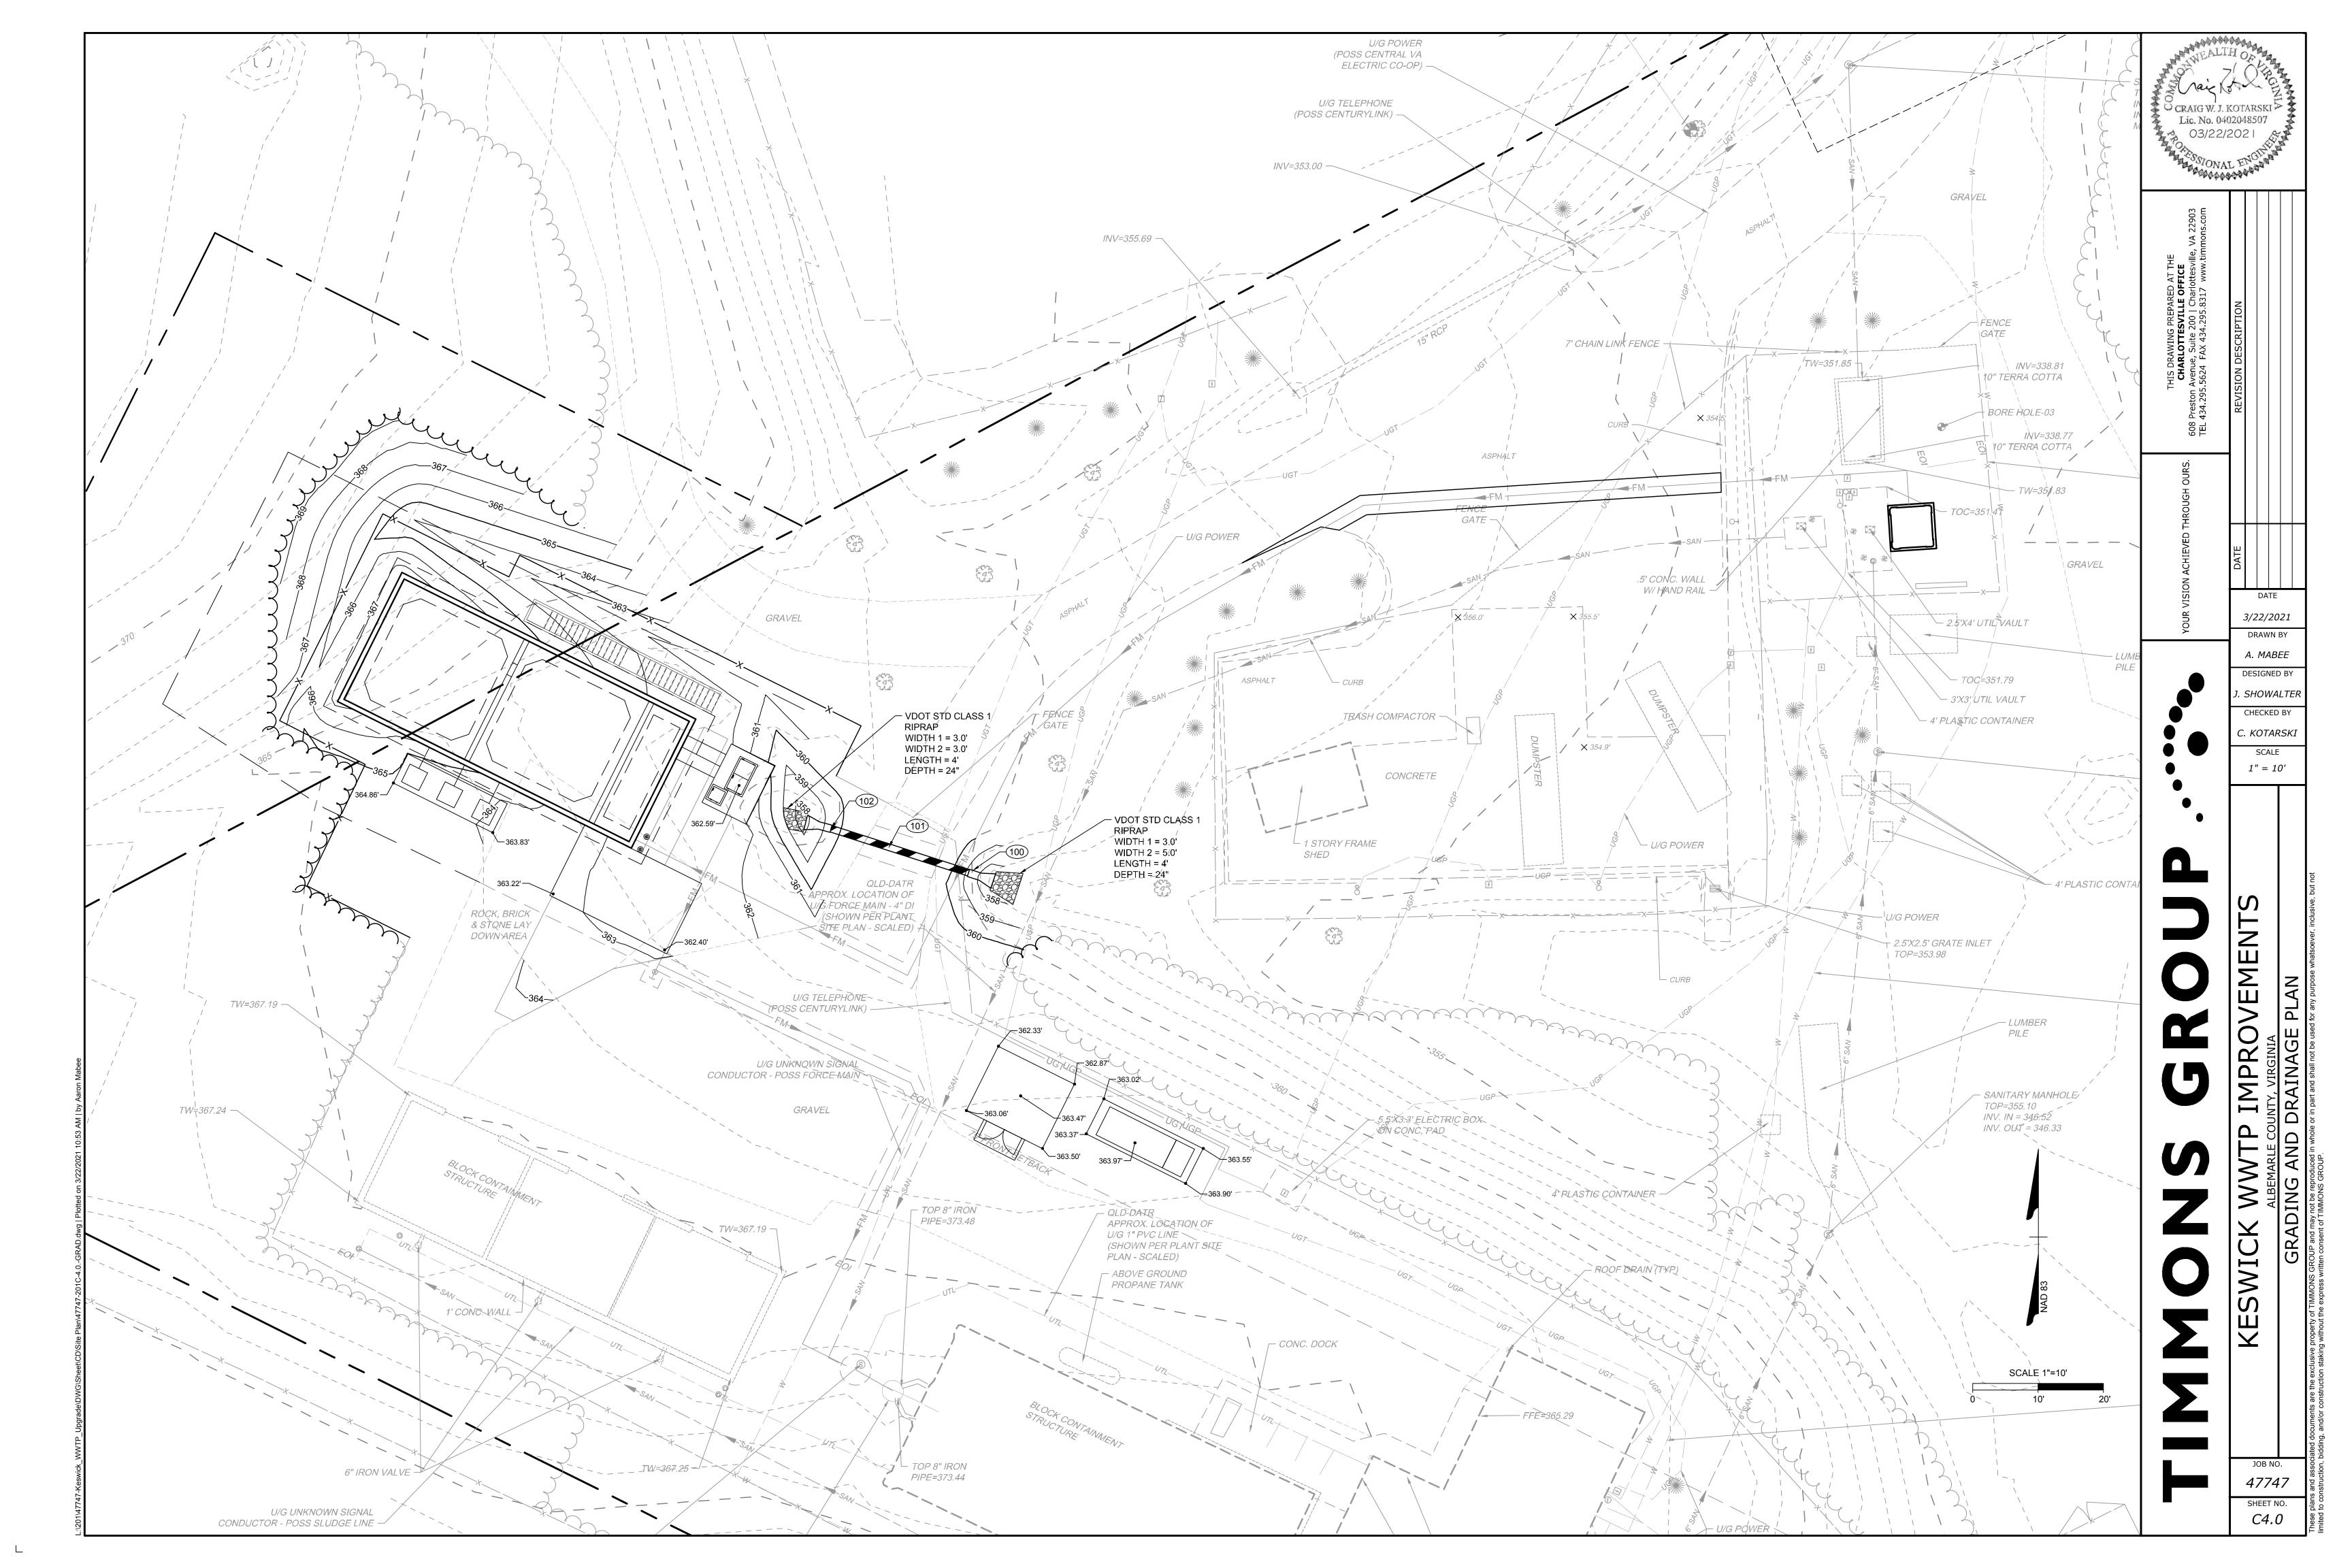
AS SHOWN


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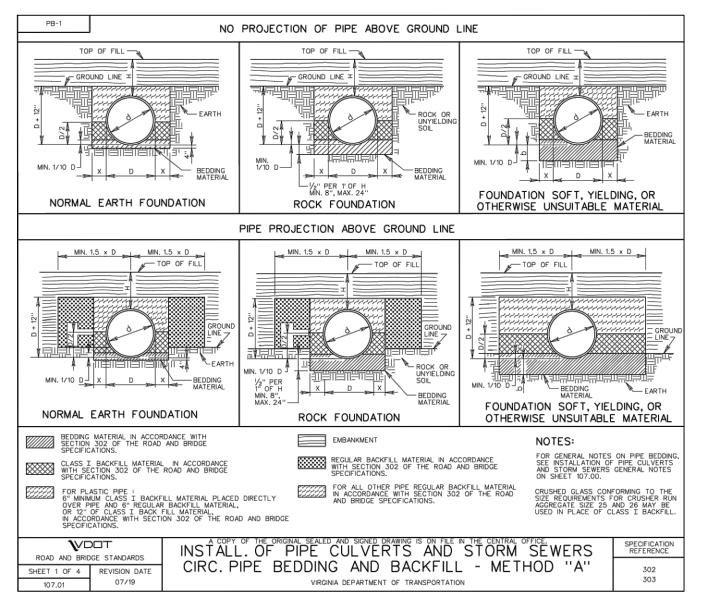
SHEET NO.






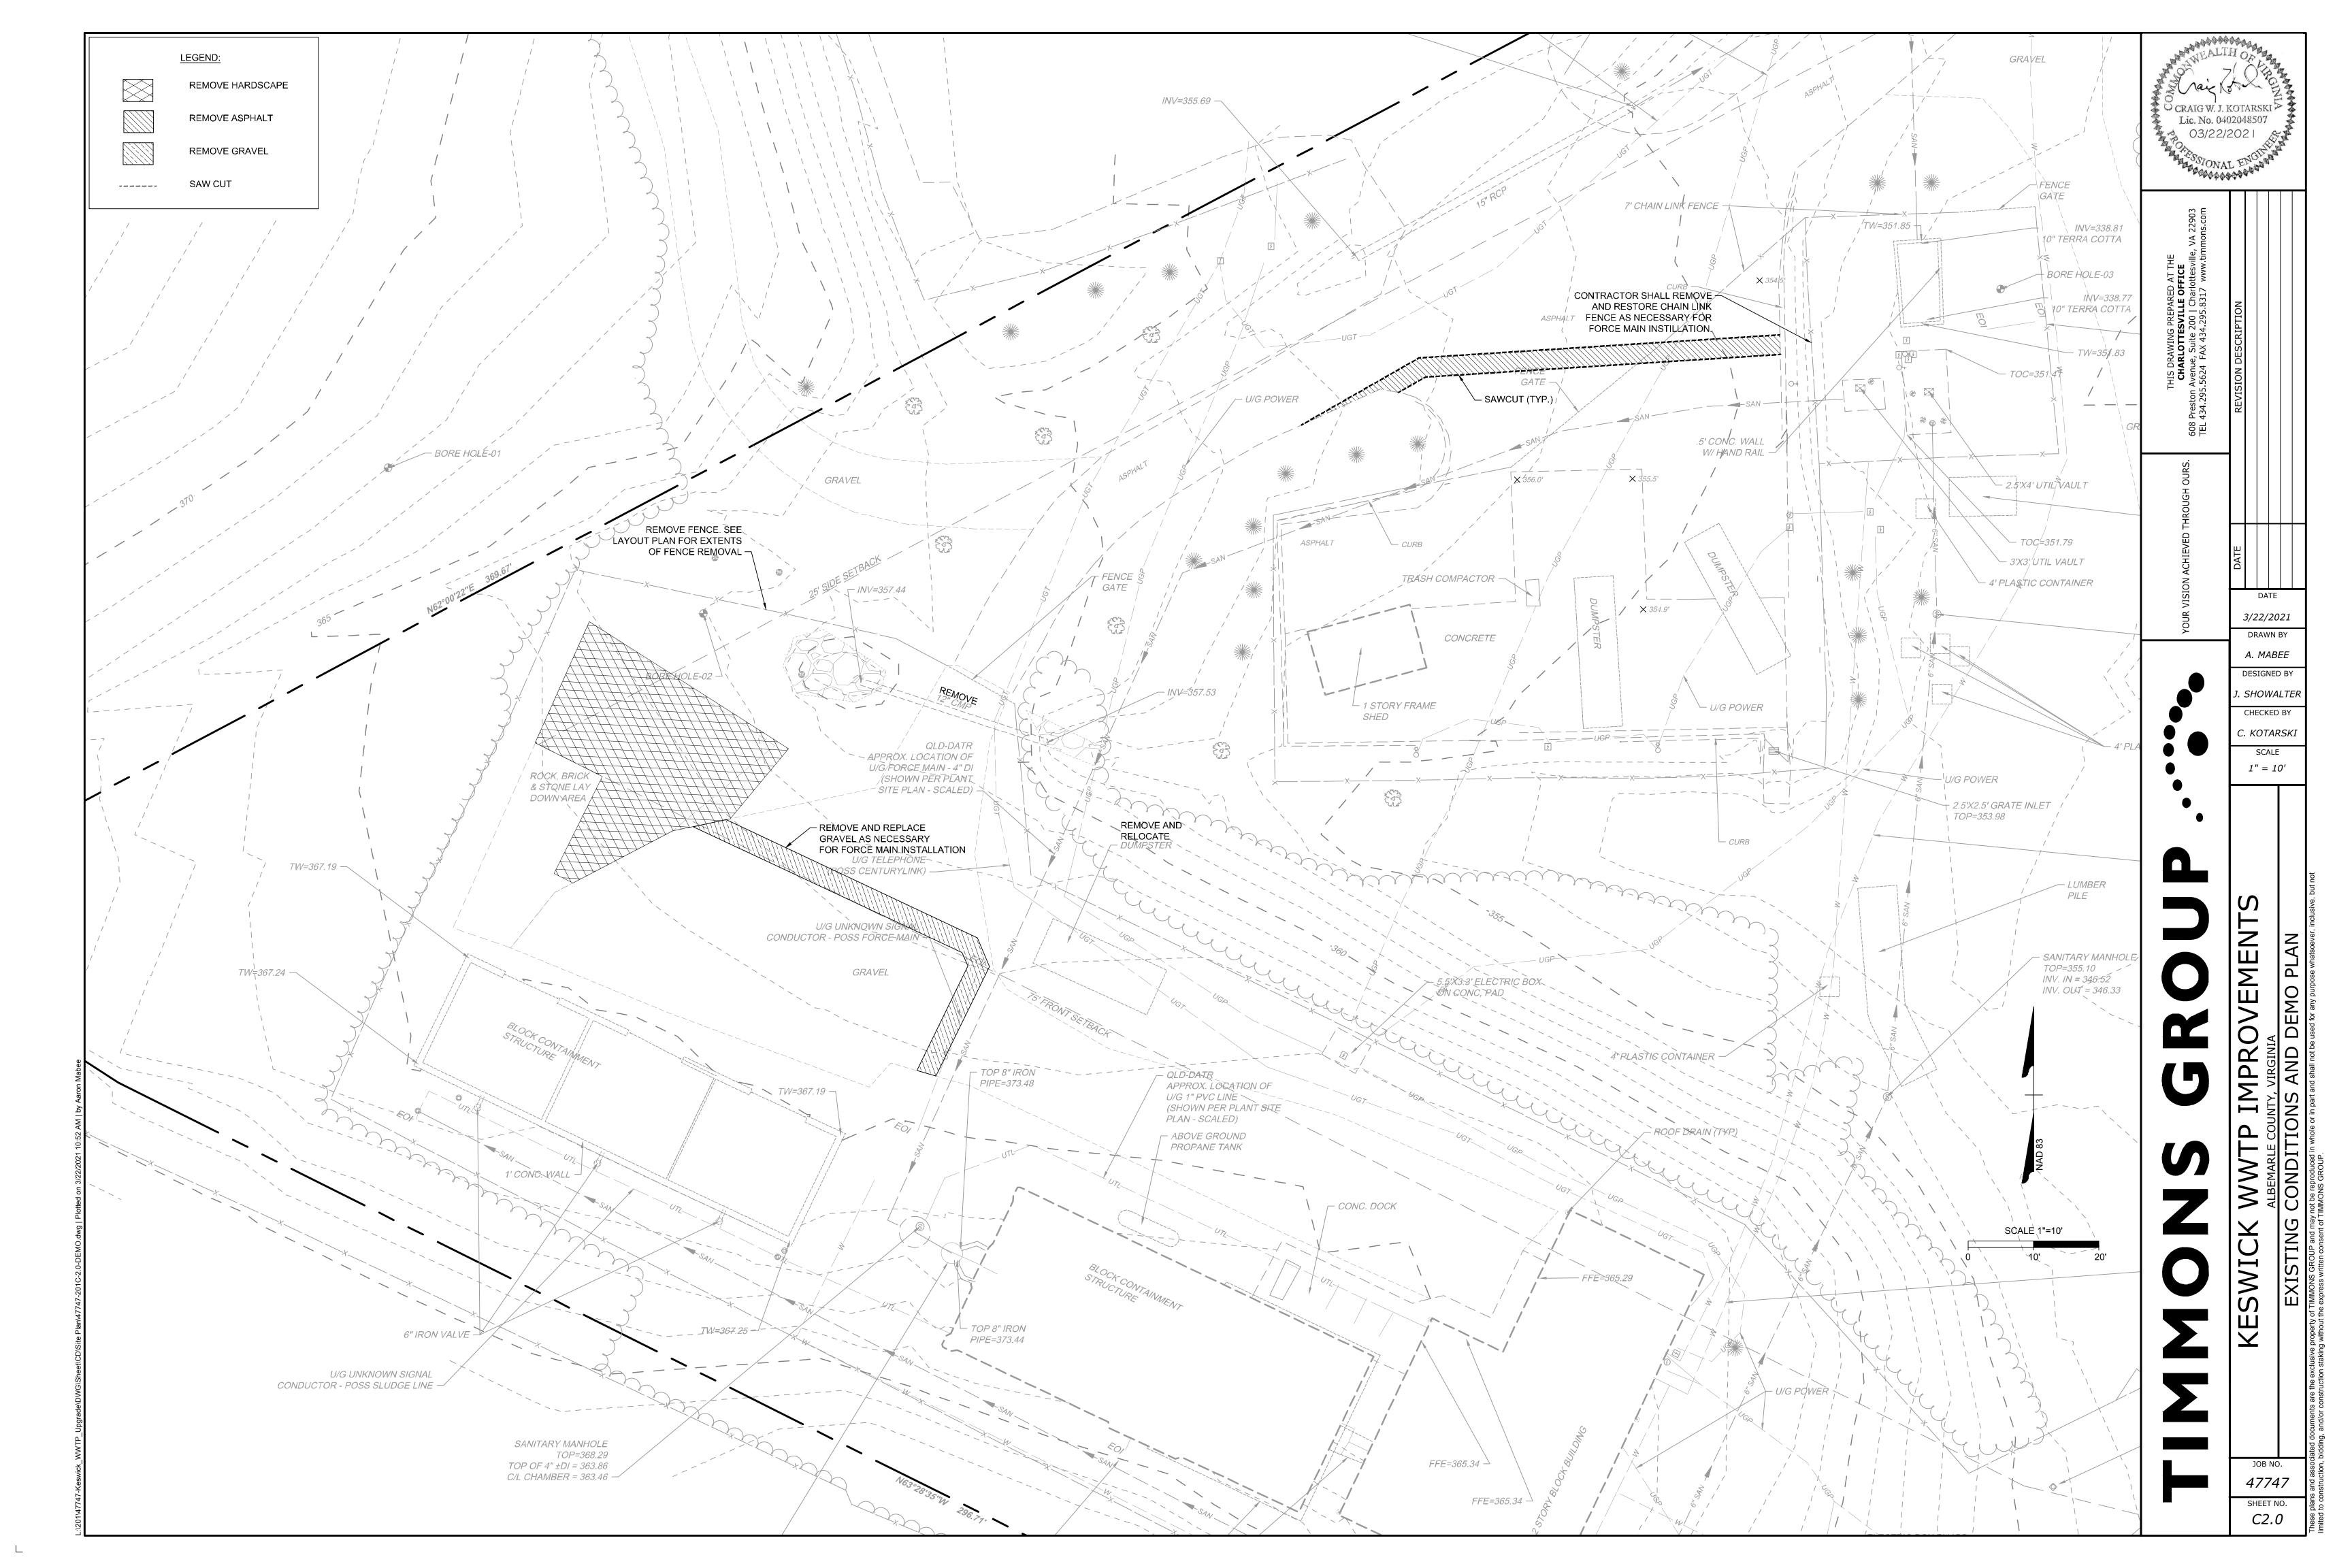

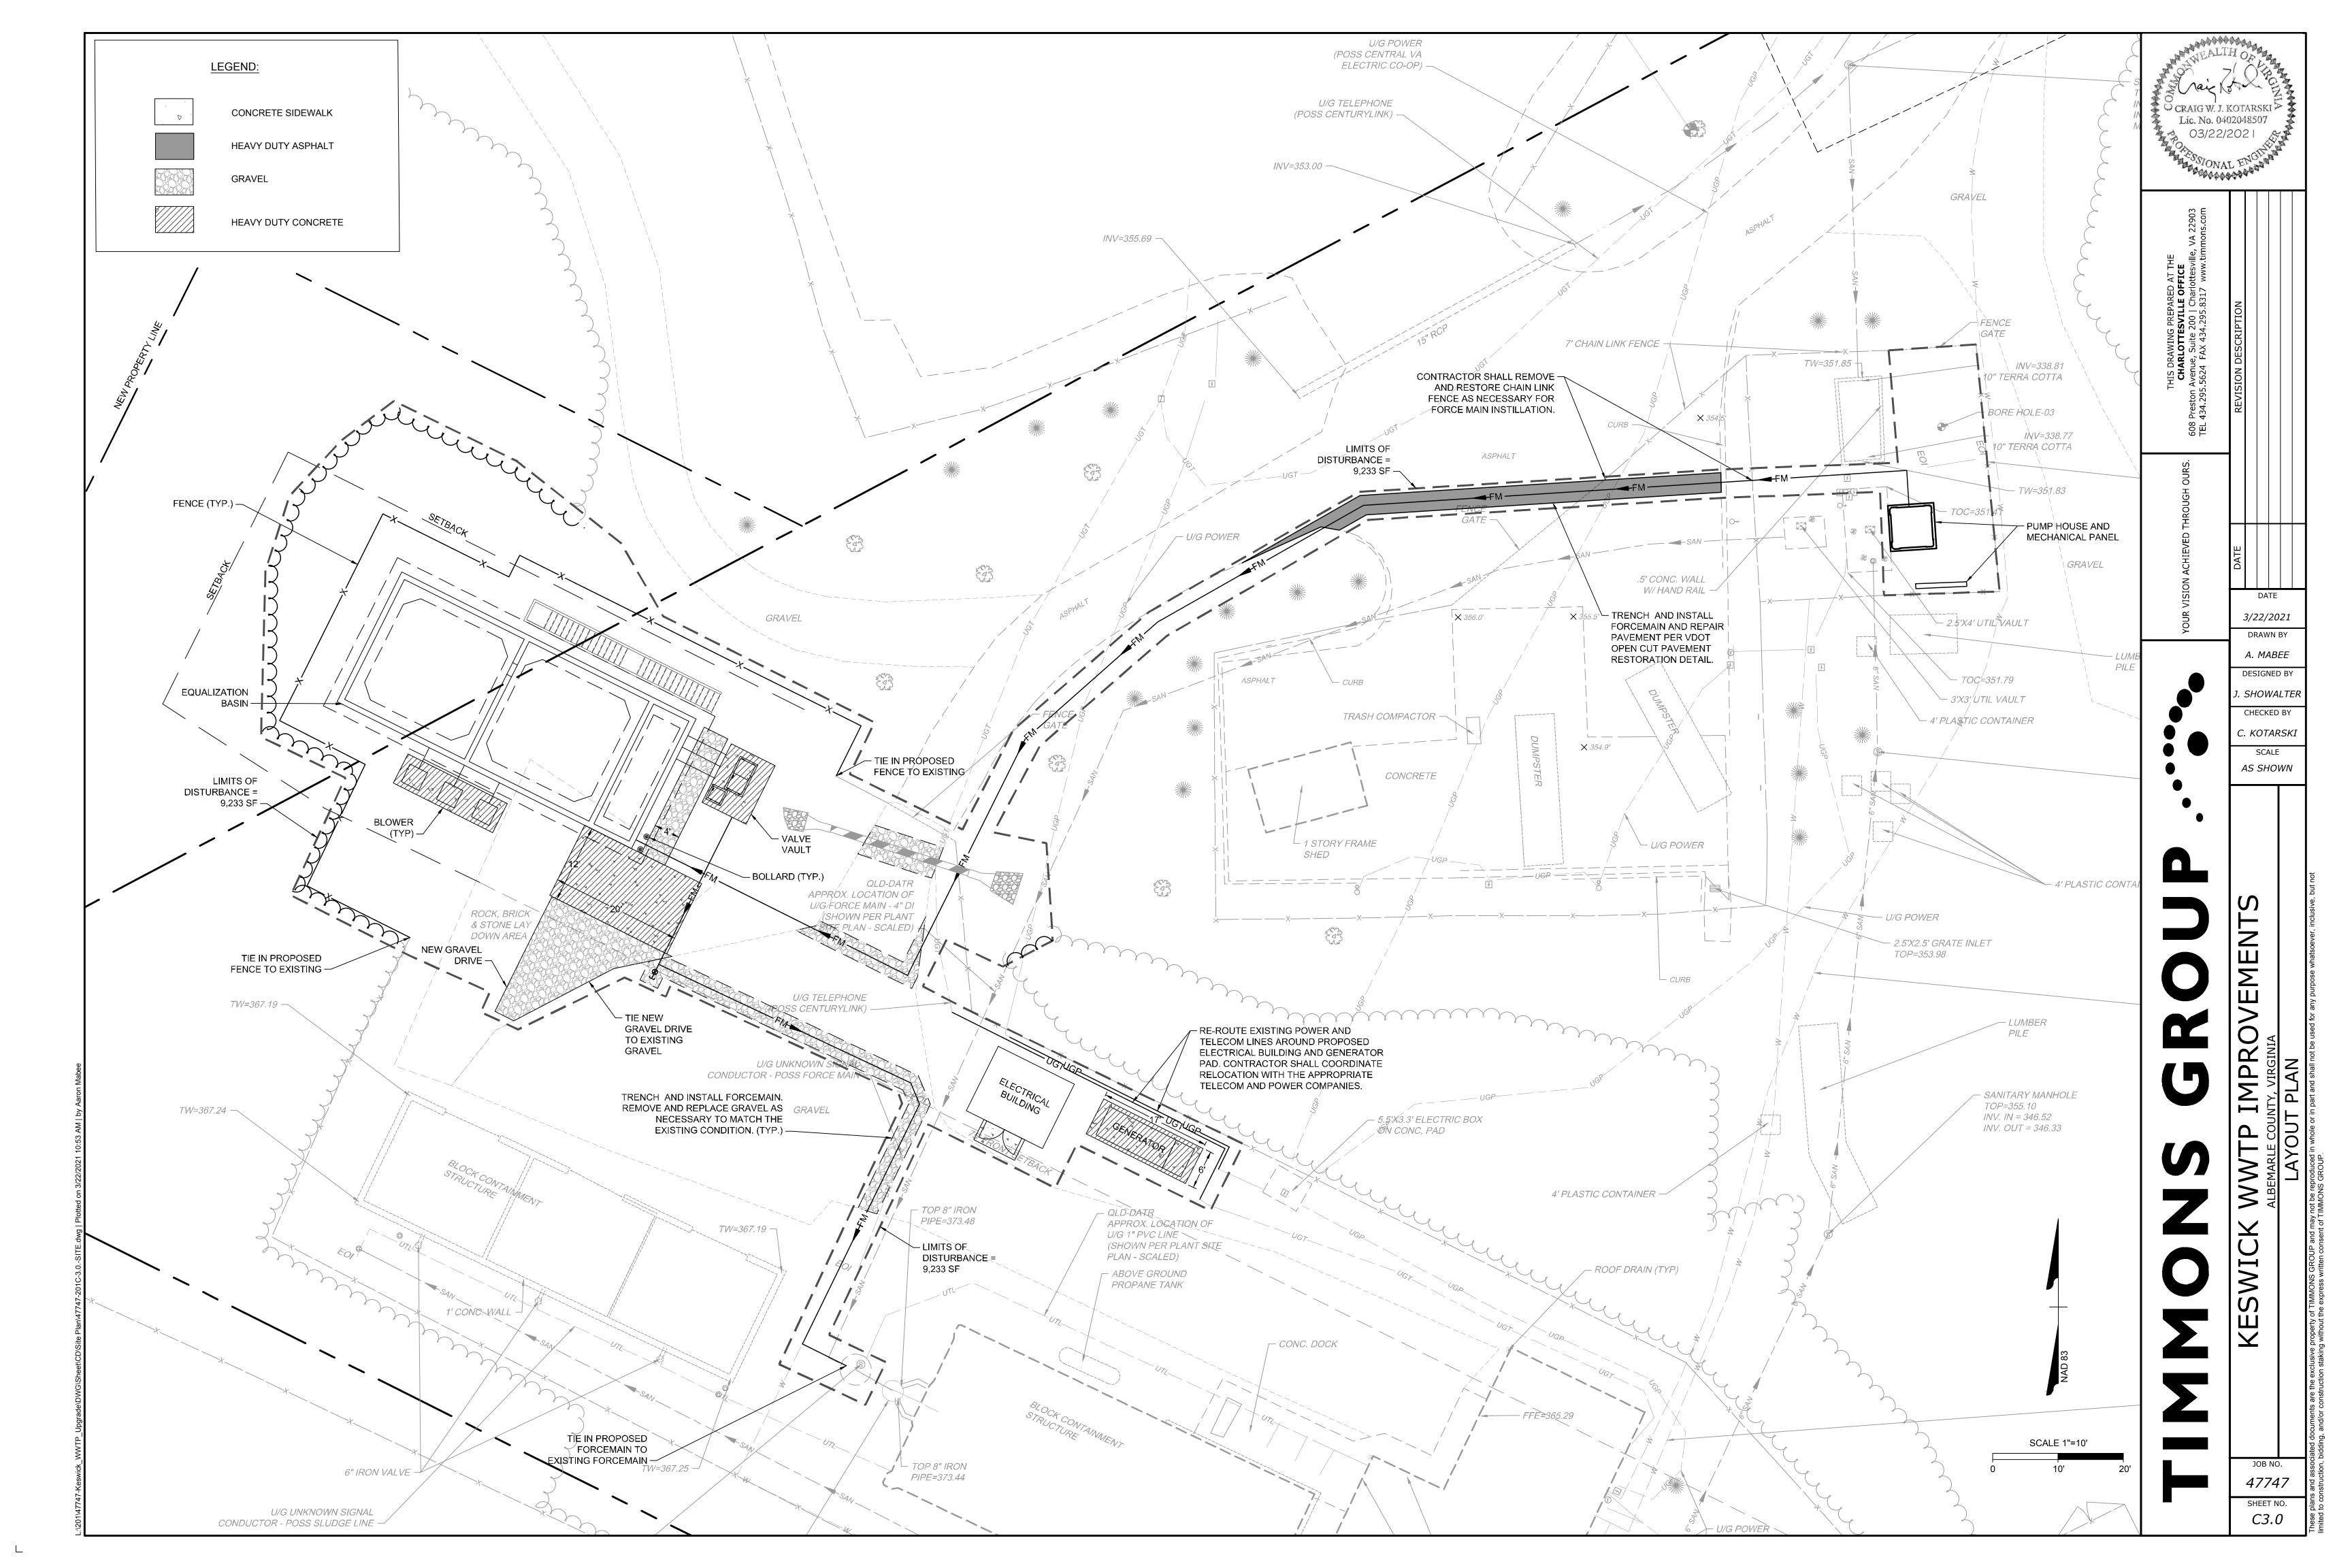

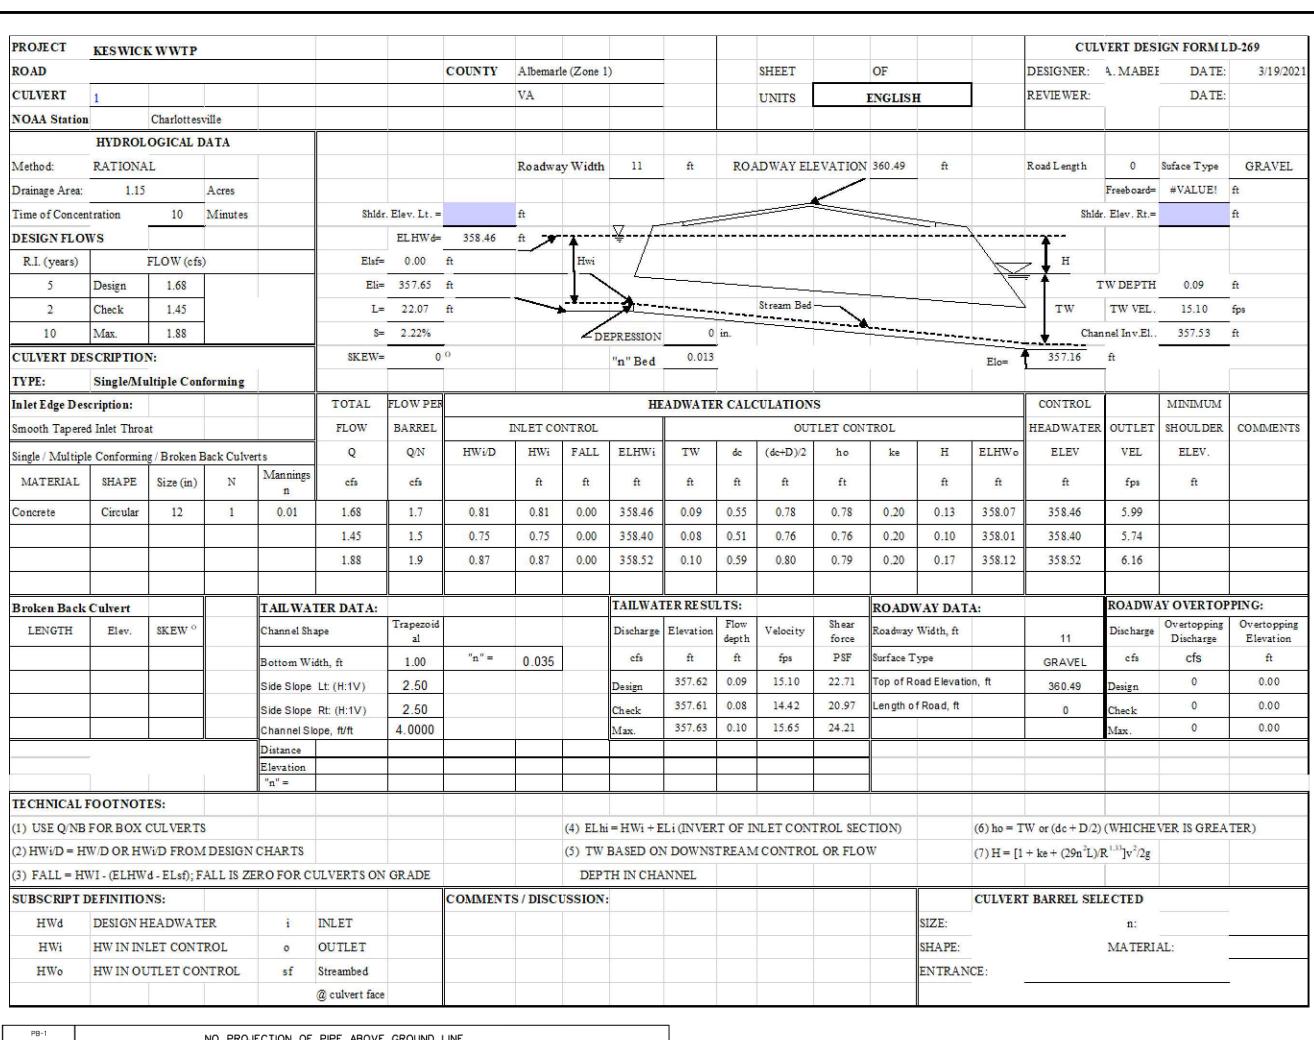

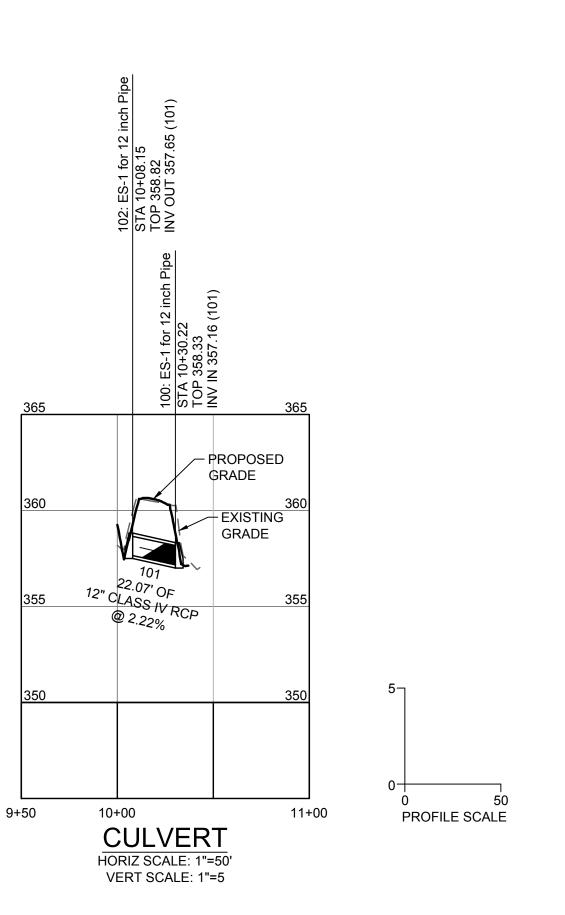

3/22/2021 A. MABEE DESIGNED BY . SHOWALTER CHECKED BY C. KOTARSKI AS SHOWN (5

Lic. No. 0402048507

03/22/2021

DATE

SCALE

JOB NO. 47747

SHEET NO. C5.0

FORCE MAIN NOTES:

DAMAGED.

- 1. DUCTILE IRON PIPE SHALL MEET THE REQUIREMENTS OF AWWA C111/C150/C151 & DUCTILE IRON PIPE FITTINGS SHALL MEET THE REQUIREMENTS OF AWWA C110/C153. PIPE & FITTINGS SHALL HAVE A 40 MIL (NOMINAL THICKNESS) PROTECTO 401 EPOXY LINING IN COMPLIANCE WITH AWWA C116 AND A BITUMINOUS SEAL COATING.
- 2. DUCTILE IRON PIPE FITTINGS SHALL BE PRESSURE CLASS 250 AND HAVE MECHANICAL JOINTS CONFORMING TO THE REQUIREMENTS OF AWWA C111.
- 3. INSTLLATION OF DUCTILE IRON PIPE AND APPURTENANCES SHALL CONFORM TO AWWA C600.
- 4. FORCE MAIN SHALL HAVE A MINIMUM OF 3.5 FEET OF COVER, UNLESS NOTED OTHERWISE.
- AFTER BACKFILLING, FINISHED GRADE ABOVE THE TRENCH SHAL BE RESTORED TO ORIGINAL CONDITION.
- 6. THE LOCATION OF EXISTING UTILITIES ACROSS OR ALONG THE ROUTE OF THE PROPOSED WORK IS NOT NECESSARILY SHOWN ON THE PLANS, AND WHEN SHOWN, IS ONLY APPROXIMATELY CORRECT. IN ADDITION TO CONTACTING MISS UTILITY PRIOR TO THE START OF CONSTRUCTION, THE CONTRACTOR SHALL, ON HIS OWN INITIATIVE, LOCATE ALL EXISTING UNDERGROUND LINES, FACILITIES, AND STRUCTURES. THE CONTRACTOR IS RESPONSIBLE FOR REPAIRING ANY UNDERGROUND LINES, FACILITIES, AND STRUCTURES

NOTES:

- THRUST RESTRAINTS SHALL BE PROVIDED ON ALL VALVES, FITTINGS, BENDS, TEES AND DEAD ENDS.
- 2. THRUST RESTRAINTS SHALL EXTEND A FULL JOINT OF PIPE IN EACH DIRECTION (20 FEET MINIMUM).
- 3. ADDITIONAL RESTRAINED LENGTH SHALL BE PROVIDED WHERE INDICATED BELOW. THRUST RESTRAINTS SHALL BE MANUFACTURED BY EBAA IRON OR APPROVED EQUAL AND THE SERIES AS INDICATED:

DUCTILE IRON PIPE AND MECHANICAL JOINTS: SERIES 1100
DUCTILE IRON PIPE PUSH ON JOINTS: SERIES 1700
PVC PIPE TO MECHANICAL JOINTS: SERIES 2000PV
PVC PUSH ON JOINTS: SERIES 2800


6" FORCE MAIN (CL 52 DIP) RESTRAINT LENGTHS


FITTING	LENGTH	NOTES
11.25° BEND	20'	EACH DIRECTION
22.5° BEND	20'	EACH DIRECTION
45° BEND	20'	EACH DIRECTION
90° BEND	40'	EACH DIRECTION
VALVE	60'	EACH DIRECTION

ASSUMPTIONS:

SOIL TYPE: MH (GRANULAR FILL)
SAFETY FACTOR: 2
TRENCH TYPE: 4
DEPTH OF BURY: 3.5'
TEST PRESSURE: 150 P.S.I.

6" FORCE MAIN RESTRAINED JOINT NOTES

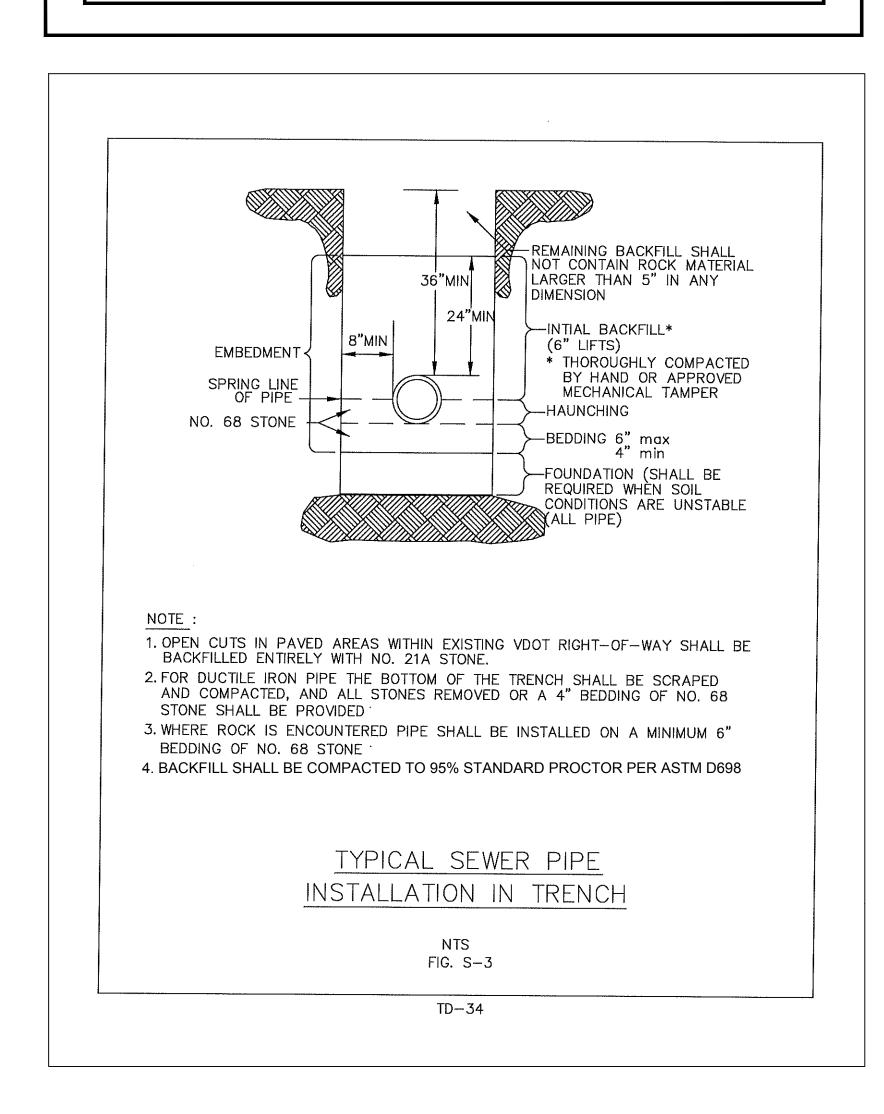

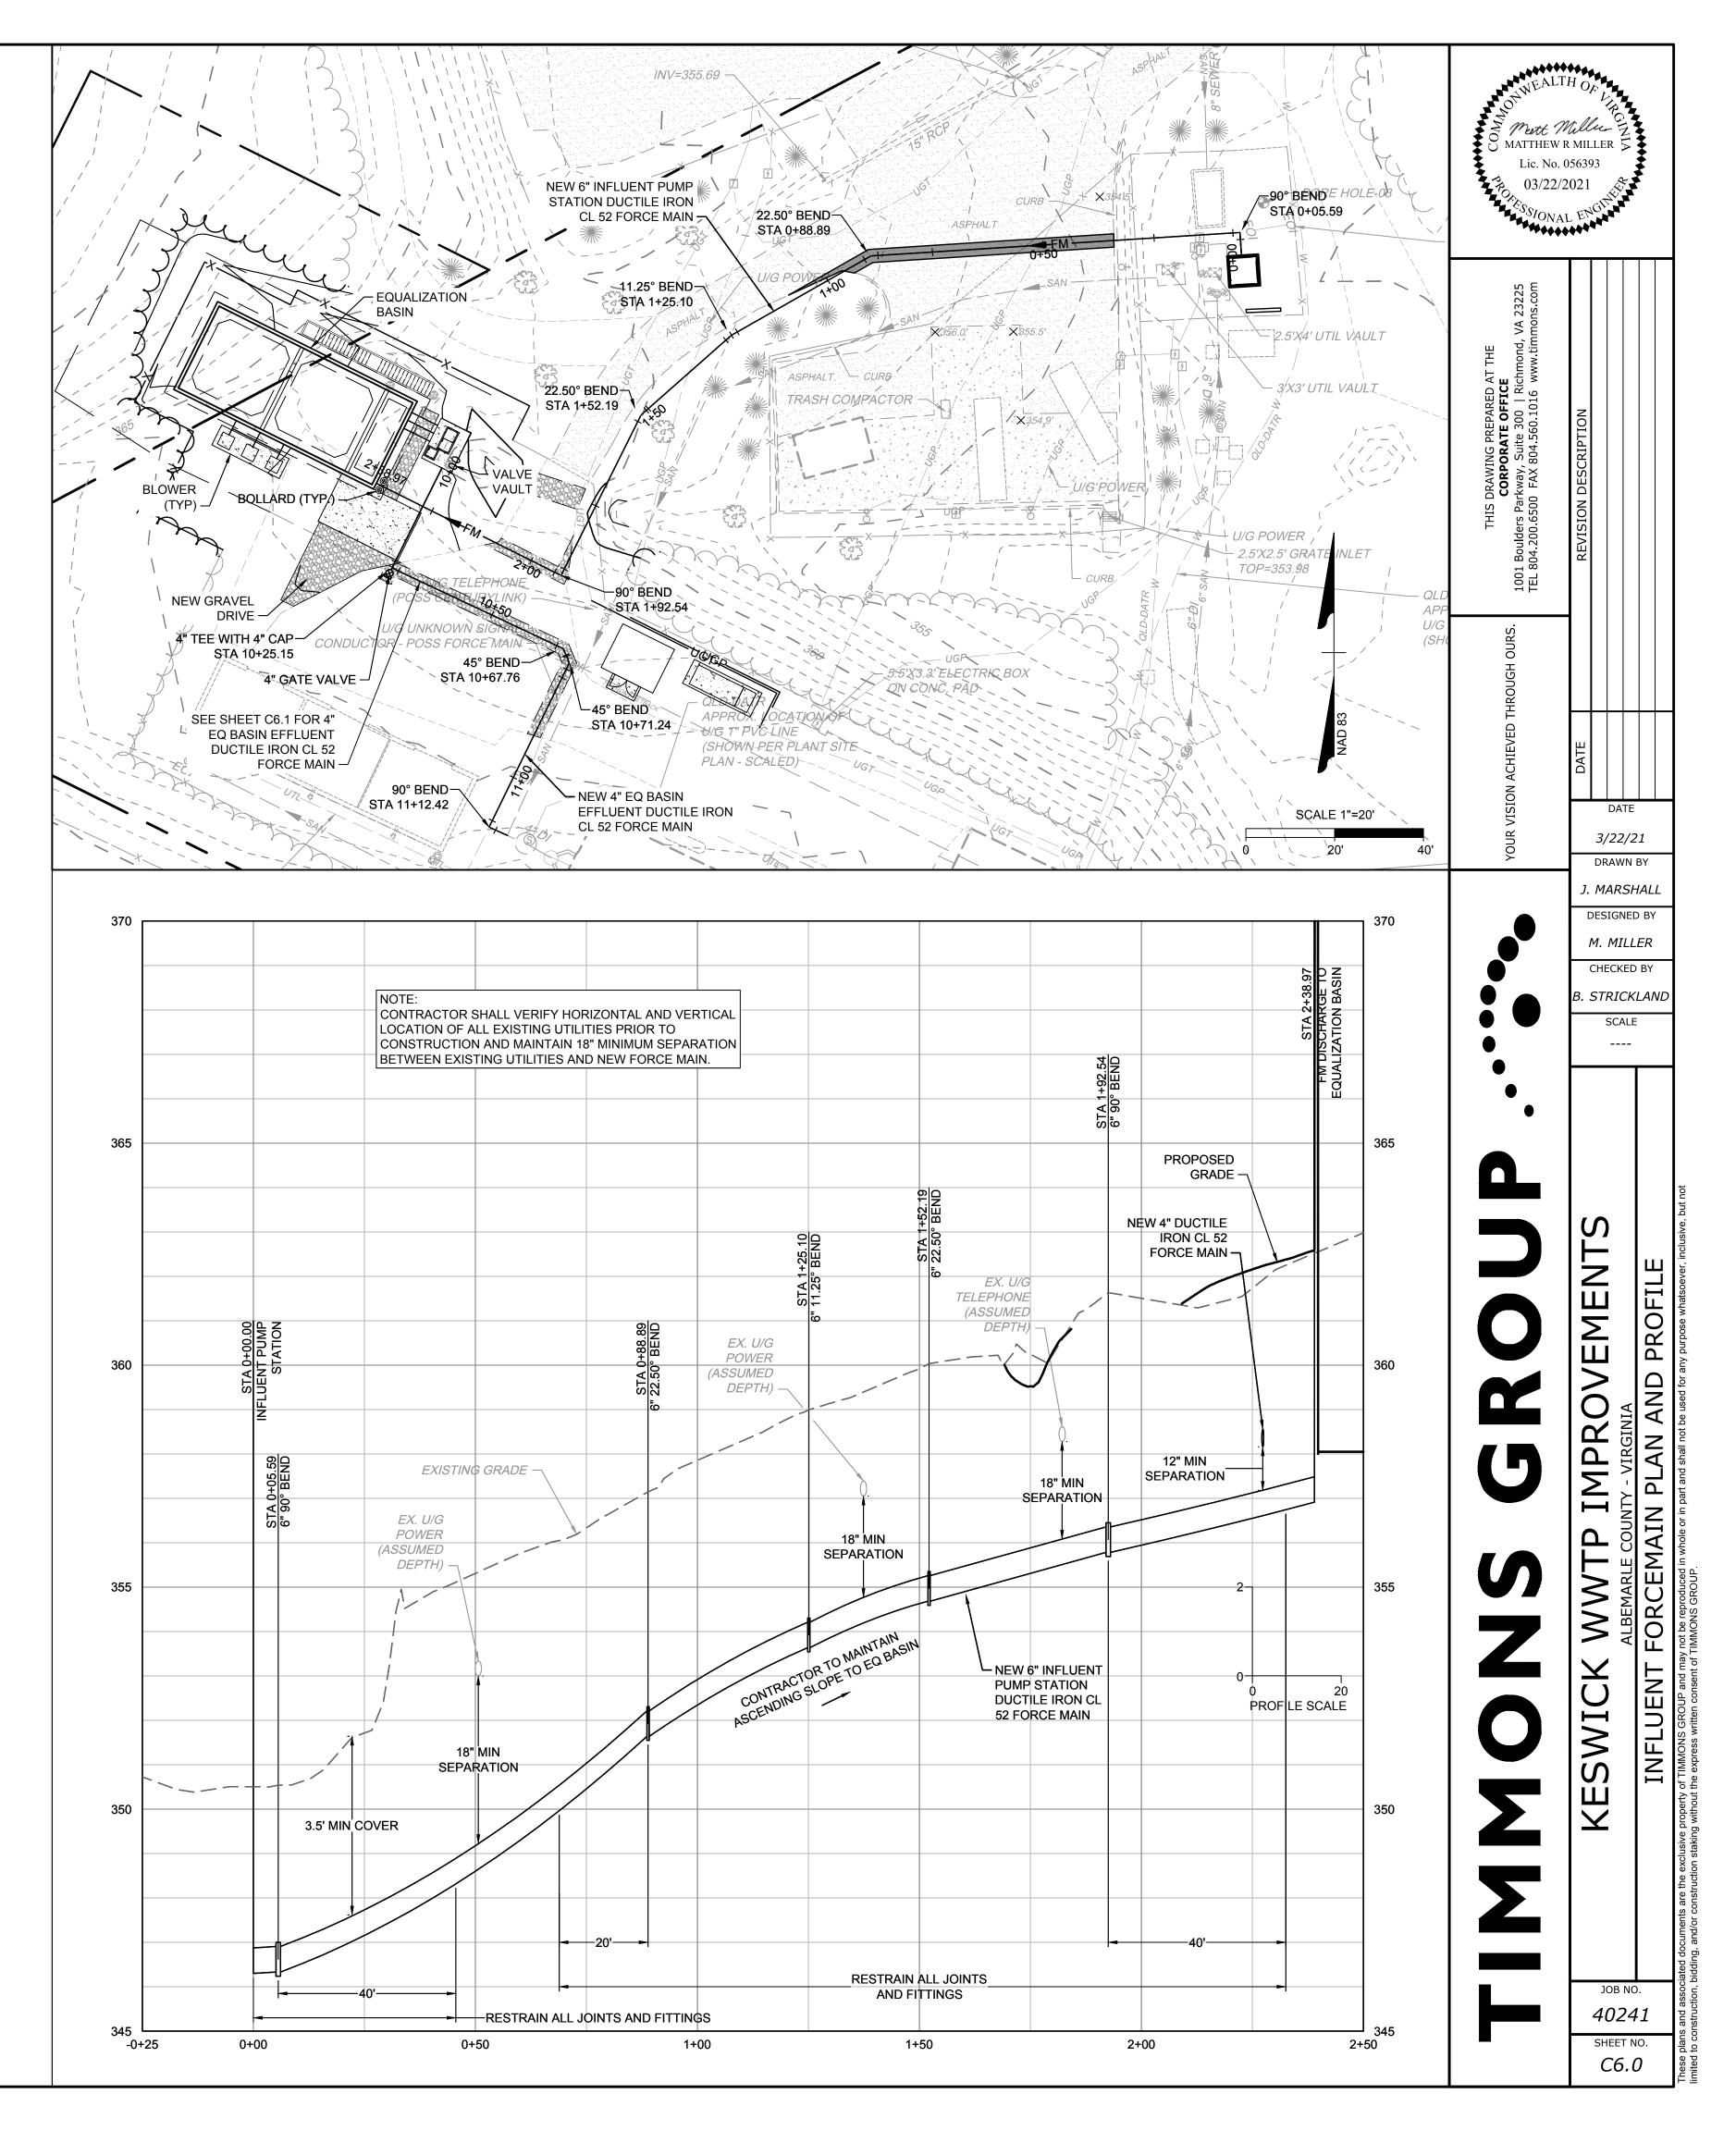

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FORCE MAIN NOTES:

DAMAGED.

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UNDERGROUND LINES, FACILITIES, AND STRUCTURES

NOTES:

- 1. THRUST RESTRAINTS SHALL BE PROVIDED ON ALL VALVES, FITTINGS, BENDS, TEES AND DEAD ENDS.
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DUCTILE IRON PIPE PUSH ON JOINTS: SERIES 1700
PVC PIPE TO MECHANICAL JOINTS: SERIES 2000PV
PVC PUSH ON JOINTS: SERIES 2800

4" FORCE MAIN (CL 52 DIP) RESTRAINT LENGTHS

FITTING	LENGTH	NOTES
11.25° BEND	20'	EACH DIRECTION
22.5° BEND	20'	EACH DIRECTION
45° BEND	20'	EACH DIRECTION
90° BEND	20'	EACH DIRECTION
VALVE	40'	EACH DIRECTION

ASSUMPTIONS:

DEPTH OF BURY:


TEST PRESSURE:


SOIL TYPE: MH (GRANULAR FILL)
SAFETY FACTOR: 2
TRENCH TYPE: 4


4" FORCE MAIN RESTRAINED JOINT NOTES

3.5'

150 P.S.I.

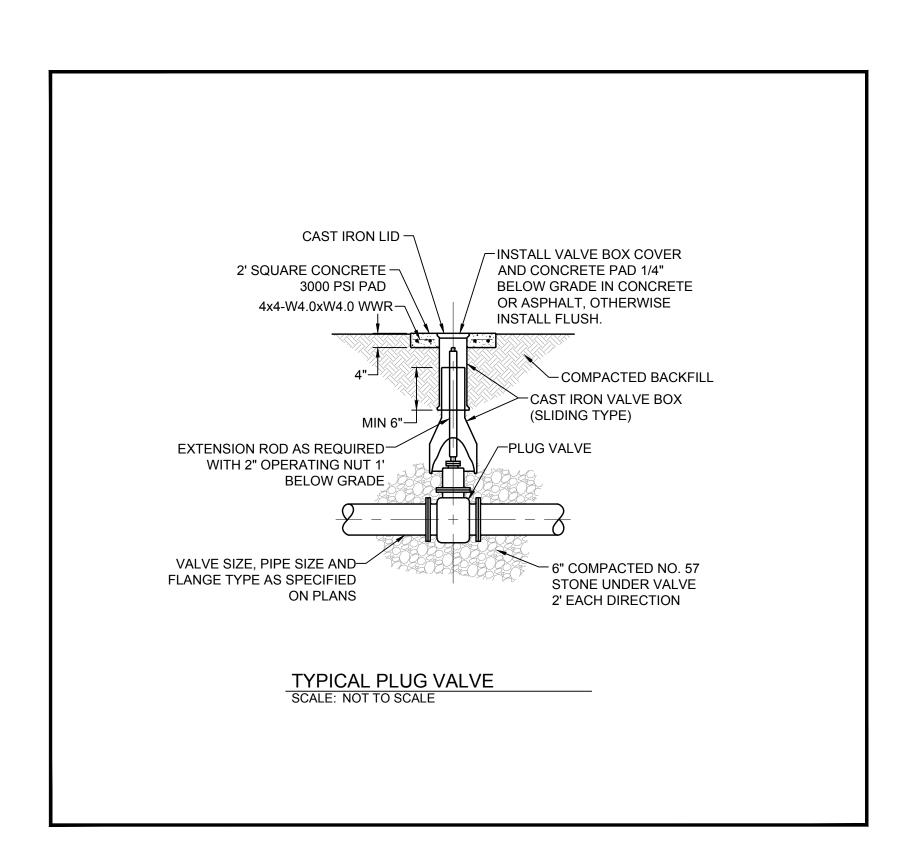

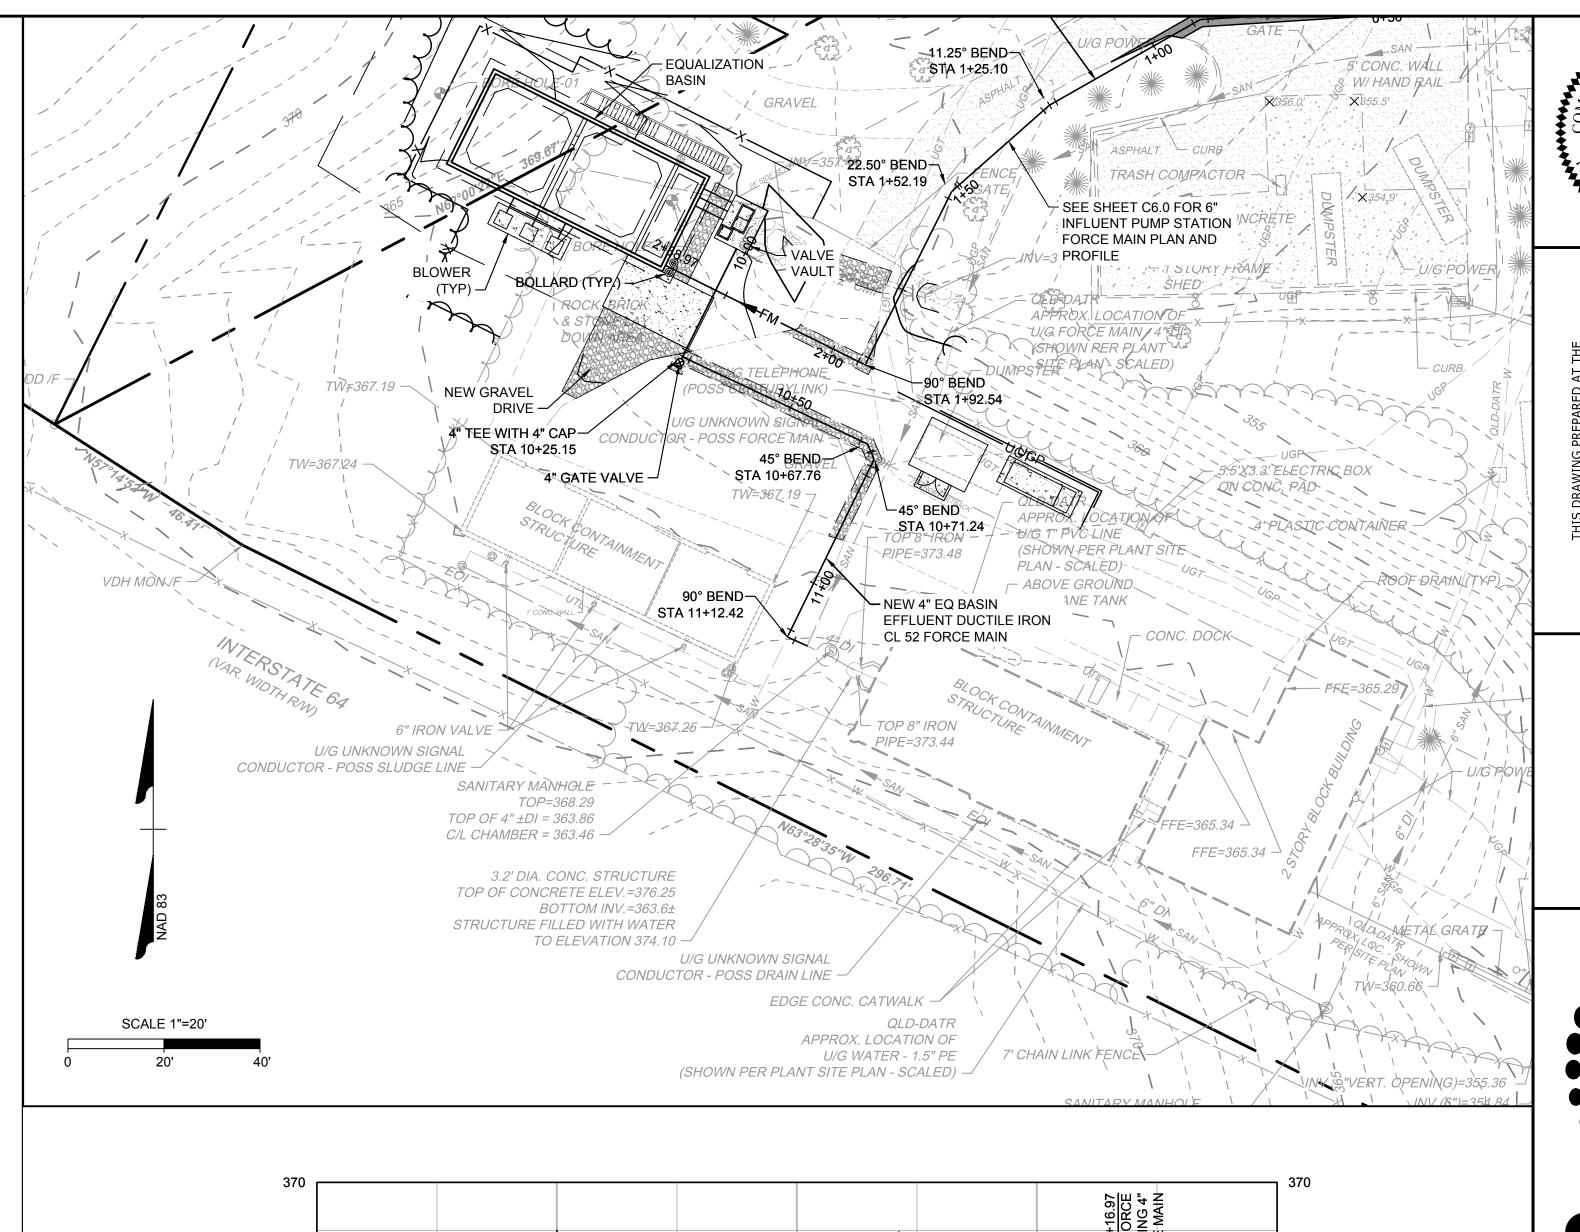

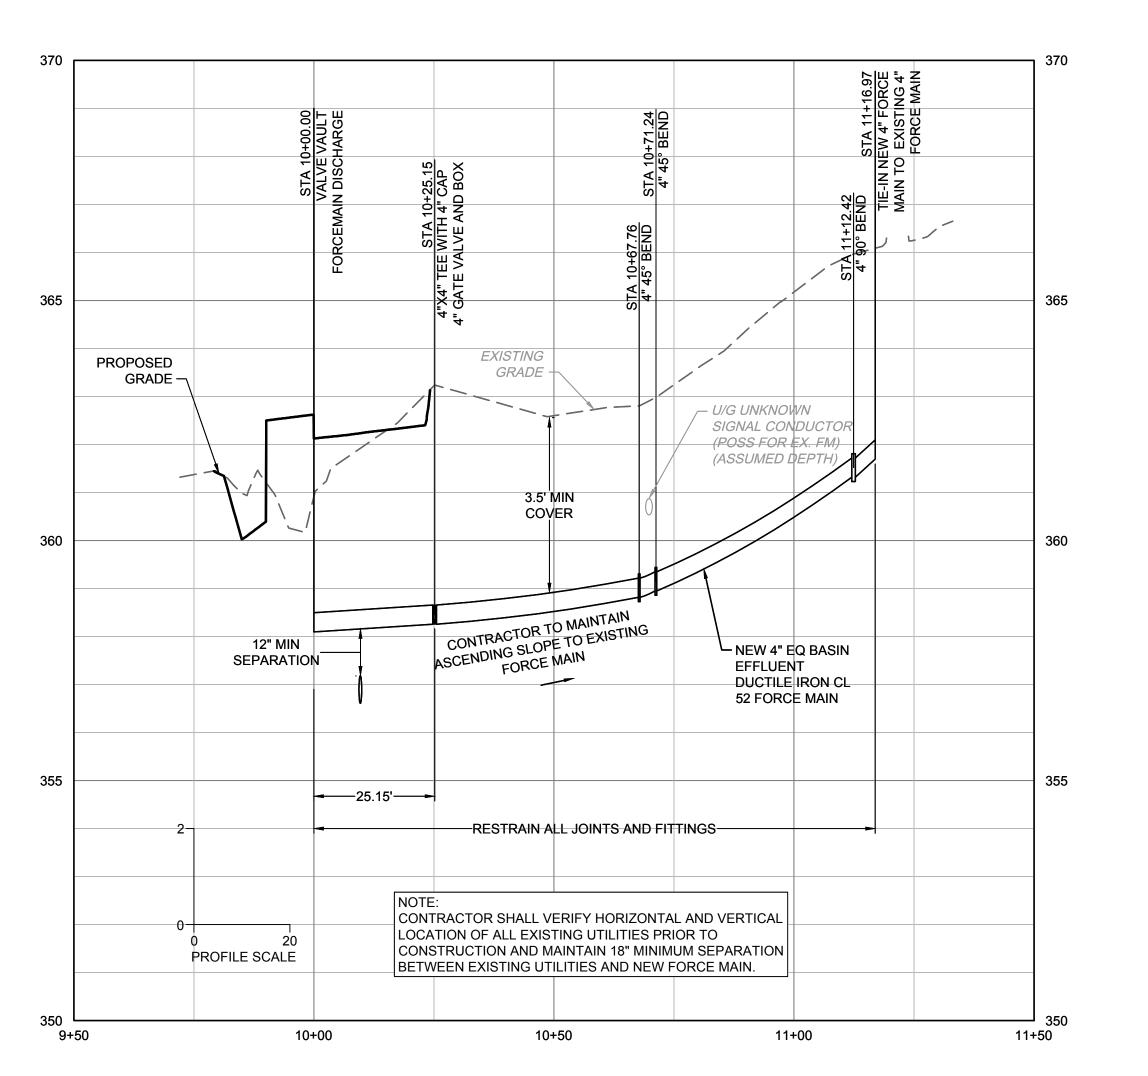

3/22/21 DRAWN BY I. MARSHALL DESIGNED BY M. MILLER CHECKED BY STRICKLAND SCALE ()

> ов NO. 40241

> SHEET NO. **C6.1**

Mett Miller

MATTHEW R MILLER

Lic. No. 056393

03/22/2021

AND PROFILE.dwg | Plotted on 3/20/2021 11:55 AM | by Lina K

